

DUNDAS PLANNING COMMISSION Public Hearing and Regular Meeting Agenda Monday, August 28, 2023 6:00 PM City Hall

- 1. CALL TO ORDER a. Roll Call
- 2. PUBLIC FORUM/PRESENTATIONS (non-agenda items)
- 3. APPROVAL OF AGENDA
- 4. APPROVAL OF MINUTESa. Public Hearing and Regular Minutes of April 20, 2023
- 5. PUBLIC HEARING

A. Consider Approving Preliminsary Plat and Planned Unit Development Amendment for a Retail Store in the Dundas Commercial Park at 540 and 600 Schilling

- i. Open Public Hearing at _____p.m.
- ii. Staff Presentation*
- iv. Public Comment
- v. Closed Public Hearing ____ p.m.
- B. Consider Comprehensive and Zoning Amendments Related to the Addition of a General Commercial Land Use Designation to the Comprehensive Plan and a B-3, General Business Zoning District to the Zoning Ordinance and Map Along with Modifications to Non-Retail Commercial Uses in the B-2, Highway Commercial Zoning District
 - i. Open Public Hearing at _____p.m.
 - ii. Staff Presentation*
 - iv. Public Comment
 - v. Closed Public Hearing ____ p.m.
- C. Land Use/Action Items
 - A. Consider Preliminary Plat and Planned Unit Development Amendment for a Retail Store in the Dundas Commercial Park at 540 and 600 Schilling recommendation to City Council
 - B. Consider comprehensive and zoning amendments related to the addition of a General Commercial land use designation to the Comprehensive Plan and a B-3, General Business Zoning District to the zoning ordinance and map along with modifications to non-retail commercial uses in the B-2, Highway Commercial Zoning District recommendation to the City Council
 - C. Other Business
 - D. ADJOURN

CITY OF DUNDAS PLANNING COMMISSION PUBLIC HEARING AND REGULAR MEETING MINUTES THURSDAY, APRIL 20, 2023 7:00 p.m. - DUNDAS CITY HALL

UNOFFICIAL MINUTES

Present: Chair Grant Modory, Commissioners, Bruce Morlan, Luke LaCroix, Luke Swartwood, Glenn Switzer

Absent: Commissioner Larry Alderks, Commissioner Francis Boehning

Staff: City Planner Nate Sparks, City Administrator Jenelle Teppen

CALL TO ORDER

Chair Modory called the Dundas Planning Commission Public Hearing and regular meeting to order at 7:06 p.m. A quorum was present.

PUBLIC FORUM/PRESENTATIONS (non-agenda items)

APPROVAL OF AGENDA

Motion by Morlan, second by LaCroix, to approve agenda. MCU

APPROVAL OF MINUTES

Motion by Morlan, second by Swartwood, to approve the public hearing and regular meeting minutes of January 19, 2023. MCU

PUBLIC HEARING Ordinance and Zoning Map Amendments Related to Implementing the Comprehensive Plan and Establishing New Districts and Standards

Open Public Hearing: Chair Modory opened the public hearing regarding ordinance and zoning map amendments related to implementing the Comprehensive Plan and establishing new districts and standards at 7:07 p.m.

Staff Presentation: City Planner Sparks reviewed the proposed amendments to the City Code regarding the zoning code. All the proposed changes are narrowly focused on land use designations.

Sparks highlighted the specific areas of the zoning code that would be updated; non-conforming uses, required frontage, downtown parking, residential housing standards, deletion of the LDSF District, housing standards moved, impervious surface standards, new R-2 district, bed and breakfasts, corner setbacks, Hester Street additional uses, downtown split, zoning map.

After some discussion and questions/answers, the Chair closed the Public Hearing at 8:26 PM.

LAND USE/ACTION ITEMS

a. Consider Recommending Ordinance and Zoning Map Amendments Related to Implementing the Comprehensive Plan and Establishing New Districts and Standards to the City Council.

Motion by LaCroix, second by Swartwood to recommend the ordinance and zoning map amendments related to implementing the Comprehensive Plan and Establishing new districts and standards to the City Council.

ADJOURN

Motion by Morlan, second by Swartwood to adjourn at the meeting at 8:35 PM

Minutes prepared by Jenelle Teppen, City Administrator/City Clerk

PLANNING REPORT

TO:	Dundas City Council Dundas Planning Commission Jenelle Teppen, City Administrator
FROM:	Nate Sparks, City Planner
DATE:	August 28, 2023
RE:	Tractor Supply Preliminary Plat / Final Plat / Planned Unit Development / Site Plan Review

BACKGROUND

Tractor Supply Company has made an application for a Preliminary & Final Plan, Planned Unit Development, and Site Plan Review for a retail store at 540 & 600 Schilling Drive.

DEVELOPMENT DETAILS

Land Use. The City's Comprehensive Plan (Land Use Plan) guides the subject site for a Retail Commercial Land Use. The site is zoned B-2, Highway Commercial.

Planned Unit Development. The project generally meets all zoning requirements. However, the PUD established allows for greater than 30% of an outdoor sales/greenhouse area and a front yard setback of 10 feet.

The outdoor sales areas total around 27,000 square feet and the building size is about 21,250. Most of the sales area is a fenced area to the side of the building or potential sales areas on the sidewalk in front. There is also a trailer area identified to the west of the parking lot.

The front yard setbacks are proposed at 10 feet from Schilling Drive. This is inline with the other buildings along this street.

Streets. The applicant is proposing to dedicate right-of-way for the existing roads in this area.

Lots. Two lots are being proposed that both meet the minimum standards of the zoning ordinance. The other lot not being developed, at this time, will remain with the original owner.

Landscaping & Lighting. The applicant has provided landscaping and lighting plans that generally meet the City's Zoning Ordinance.

Architecture. The applicant has provided building plans that generally meet City Ordinances.


Grading, Drainage and Utilities. Issues related to grading, drainage, and utilities, including the establishment of related outlots and easements, should be subject to comment and recommendation by the City Engineer.

Additionally, the applicant must expand the side of the pond in the first phase of the development.

Development Agreement. As a condition of final plat approval, the applicant will be required to enter into a development agreement with the City and post all the necessary securities required by it. This issue should be subject to further comment by the City Attorney.

RECOMMEDATION

The Planning Commission should hold a public hearing and the City Council should consider the draft approval documents for the proposed project.

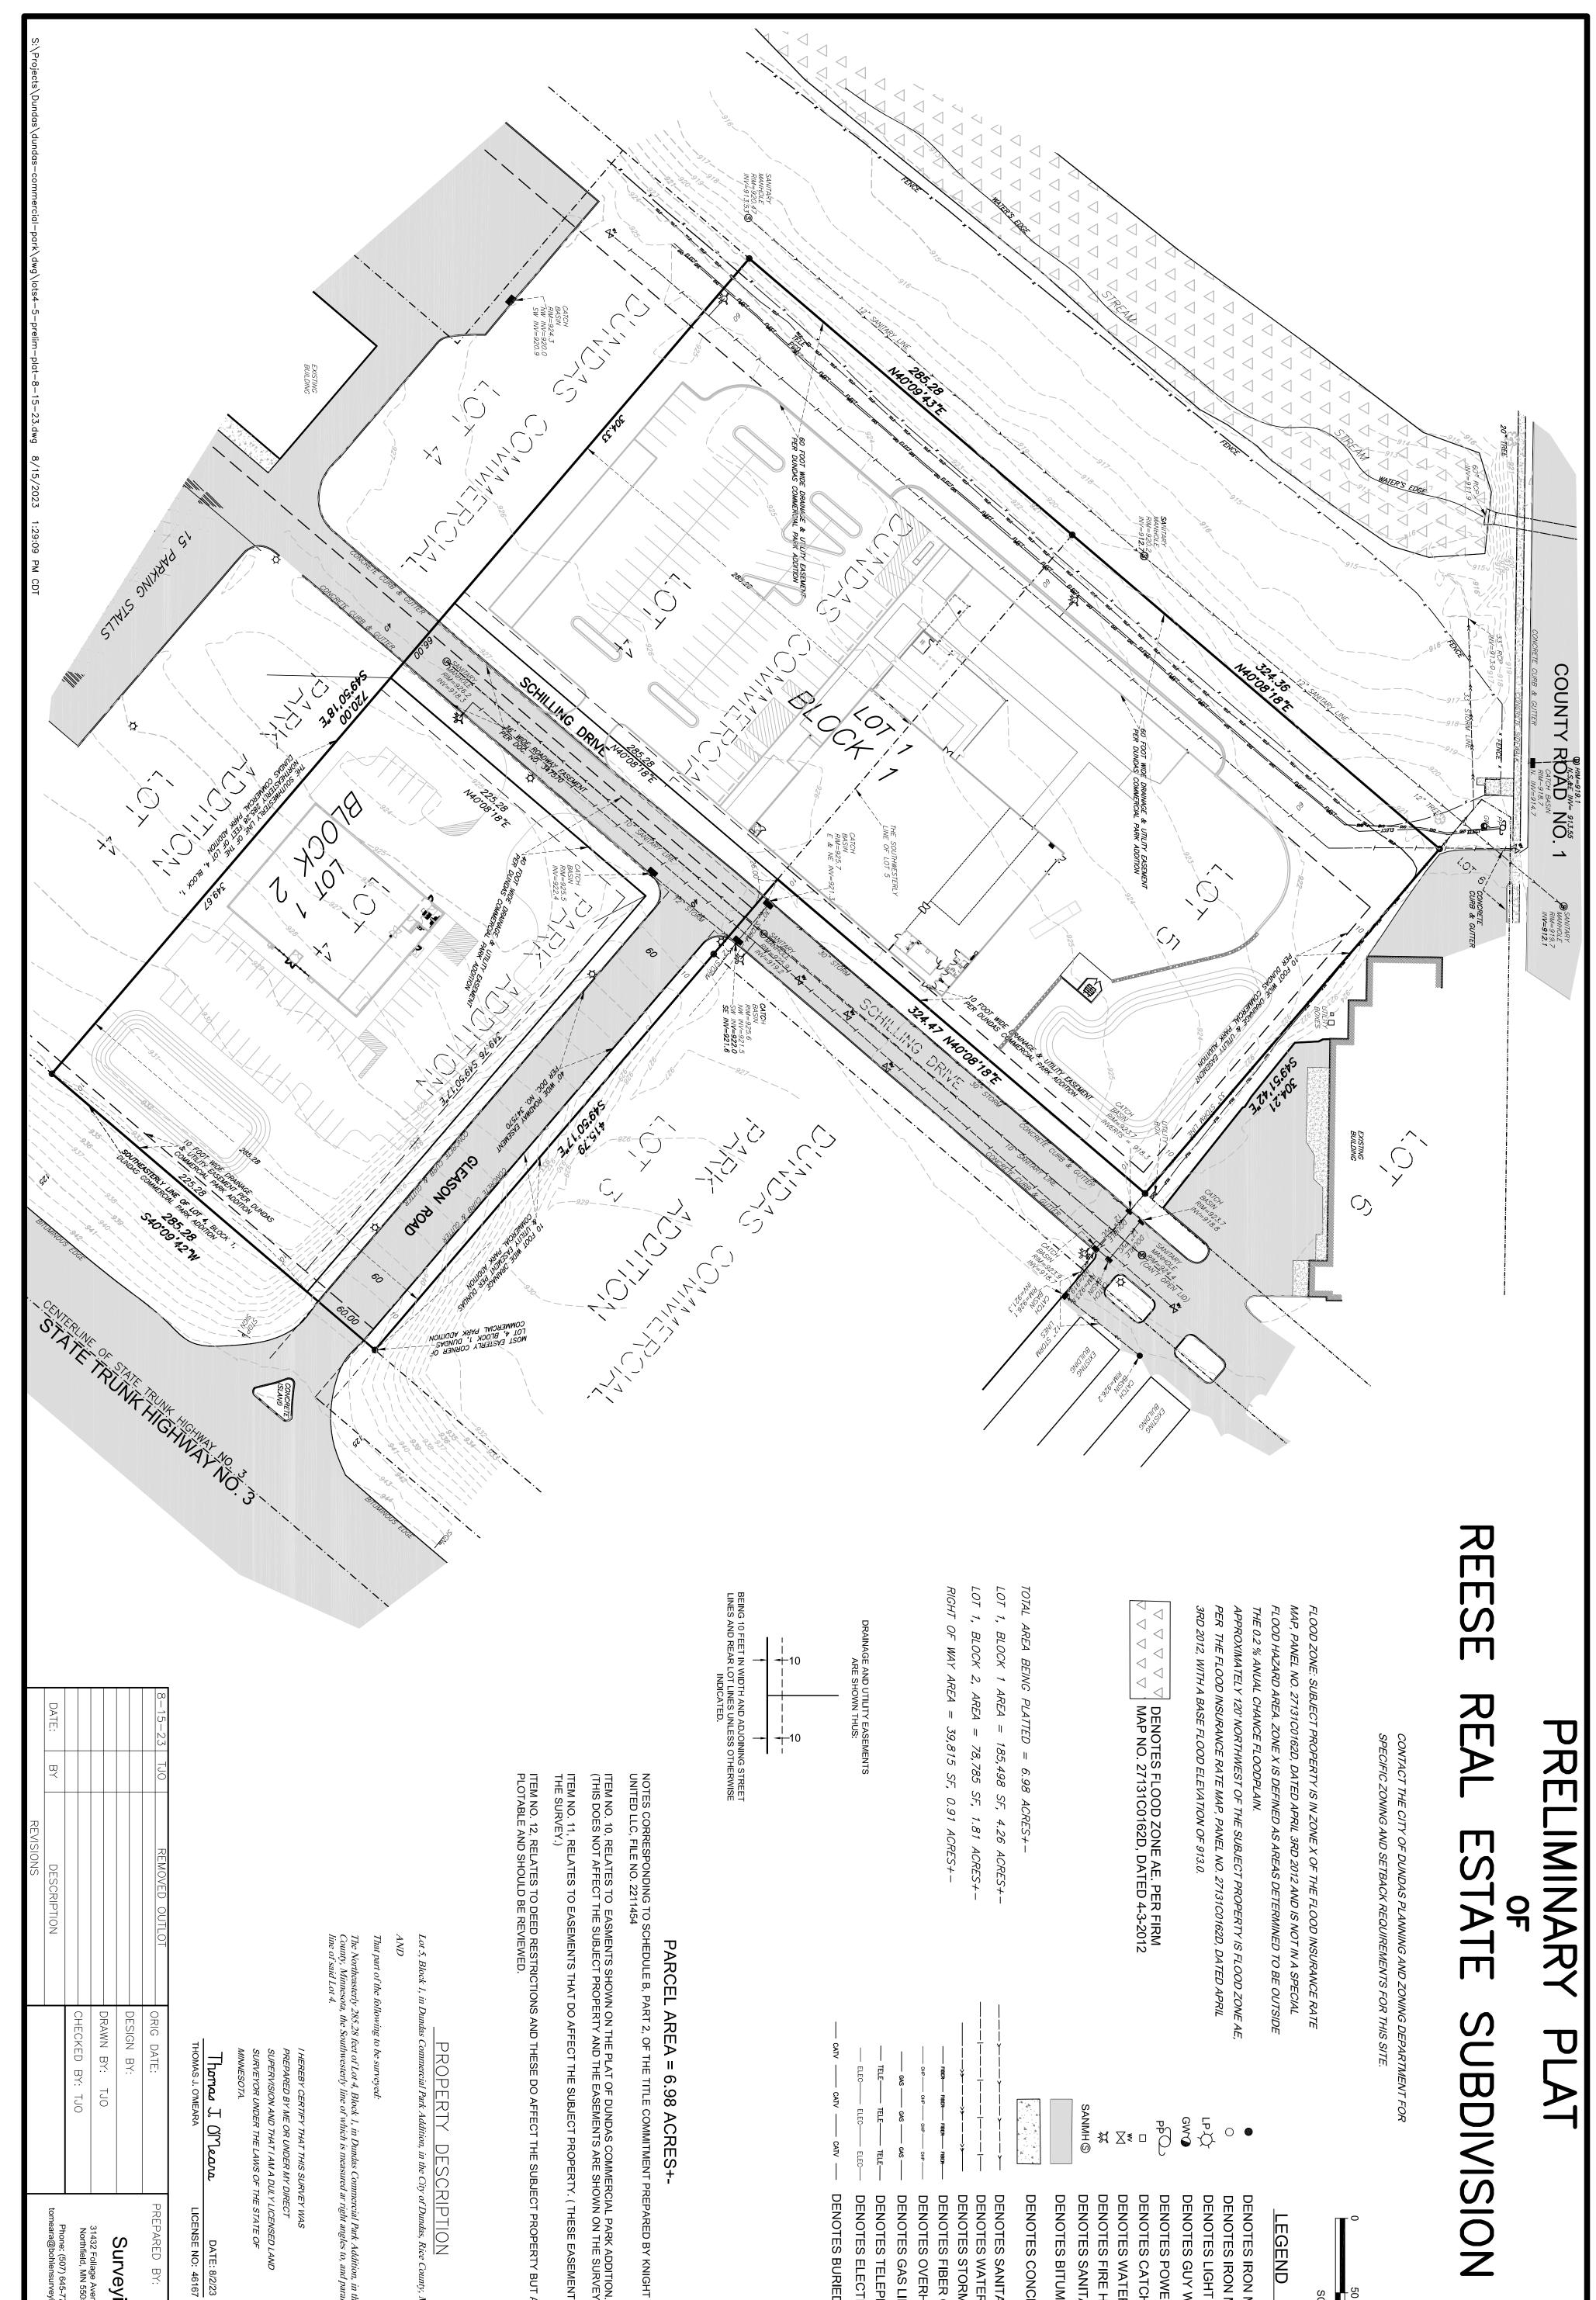

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	I HEREBY CERTIFY THAT THIS SURVEY WAS PREPARED BY ME OR UNDER MY DIRECT SUPERVISION AND THAT I AM A DULY LICENSE SURVEYOR UNDER THE LAWS OF THE STATE MINNESOTA.	URVEY WAS Y DIRECT DUL Y LICENSED LAND DF THE STATE OF
	Thomas J. O'Meana THOMAS J. O'MEARA	DATE: 8/2/23 LICENSE NO: 46167
REMOVED OUTLOT	- ORIG DATE: - DESIGN BY: - DRAWN BY: TJO	3ohlen g & As
DESCRIPTION	CHECKED BY: TJO	S1432 Follage Avenue Northfield, MN 55057 Phone: (507) 645-7768 tomeara@bohlensurveying.com Fax: (952) 895-9212



Know what's **below**. Call before you dig.



UTILITY COMPANIES:

CITY WATER: CITY OF DUNDAS

CONTACT: DUANE MELIZA PH:----EMAIL: DMELIZA@DUNDAS.US

ELECTRIC: XCEL ENERGY

CONTACT: ERIC HAGEN PH: (507) 334-2938 EMAIL: ERIC.HAGEN@XCELENERGY.COM

GAS: **XCEL ENERGY**

CONTACT: JENNIFER THURSTON PH: (218) 330-6733 EMAIL: JENNIFER.E.THURSTON@XCELENERGY.COM

CITY SEWER: CITY OF DUNDAS

CONTACT: DUANE MELIZA PH:----EMAIL:DMELIZA@DUNDAS.US

TELEPHONE: UTILITY PHONE COMPANY

CONTACT: UTILITY PHONE CONTACT PH: UTILITY PHONE # EMAIL: UTILITY PHONE EMAIL





ARCHITECT:

OXFORD ARCHITECTURE


CONTACT: LEE MORRISETTE 2934 SIDCO DRIVE NASHVILLE, TN 37204 PH: (615) 256-3455, EXT. 12 EMAIL: LEE@OXFORDARCHITECTURE.COM



SITE DEVELOPMENT PLANS REESE DEV - TSC DUNDAS, MN

August 2023

PROJECT LOCATION

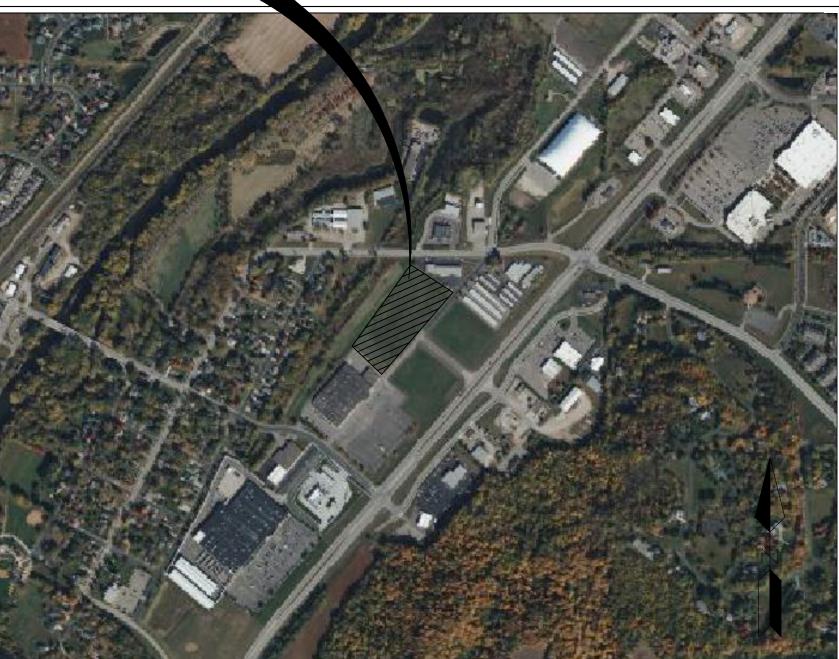

VICINITY MAP 1" = 1/8mi

SHEET INDEX			
Sheet Number Sheet Title			
C1	TITLE SHEET		
C2	GENERAL NOTES		
C3	EXISTING		
	CONDITIONS-DEMO PLAN		
C4	SITE PLAN		
C5	GRADING PLAN		
C6	UTILITY PLAN		
C7	DRAINAGE PLAN		
C8	JOINTING PLAN		
C9	EROSION CONTROL PLAN		
C10	EROSION CONTROL		
DETAILS			
C11	CONSTRUCTION DETAILS		
C12	CONSTRUCTION DETAILS		
C13	CONSTRUCTION DETAILS		
C14	CONSTRUCTION DETAILS		
C15	BORING LOGS		
C16	BORING LOGS		
C17	BORING LOGS		
L1 LANDSCAPE PLAN			

CIVIL ENGINEER:

SE3, LLC

CONTACT: MATT GAUNTT, P.E. 13747 MONTFORT DR SUITE 275 DALLAS, TX 75240 PH: 214-676-9968 OFFICE EMAIL: MGAUNTT@SE3.US

SURVEYOR:

BOHLEN SURVEYING

CONTACT: THOMAS O'MEARA 31432 FOLIAGE AVENUE NORTHFIELD, MN 55057 PH: (507) 645-7768 EMAIL: TOMEARA@BOHLENSURVEYING.COM

PREPARED BY:					
13747 MON	13747 MONTFORT DR				
SUITE 275 DALLAS, TX 75240 214-678-9968					
PREPARED FOR: REESE REAL ESTATE DEVELOPMENT PARTNERS					
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TITLE SHEET					
PROJECT NUMBER:	03-217-003				
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BML CHECKED BY:	C1 OF 18 SHEETS				
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*THE STANDARD SHEETS SPECIFICALLY IDENTIFIED ABOVE HAVE BEEN SELECTED BY ME OR UNDER MY RESPONSIBLE SUPERVISION AS BEING APPLICABLE TO THIS PROJECT.

GENERAL CONSTRUCTION NOTES

- 1. ALL SITE WORK SHALL BE PERFORMED UTILIZING MATERIAL AND METHODS IN STRICT ACCORDANCE WITH APPLICABLE SECTIONS OF THE MINNESOTA DEPARTMENT OF TRANSPORTATION - LATEST EDITION, LOCAL REQUIREMENTS, AS WELL AS THE STANDARD DETAIL SHEETS ATTACHED TO THESE PLANS. WHERE THERE IS A CONFLICT, THE MORE RESTRICTIVE SPECIFICATIONS SHALL GOVERN. THE CONTRACTOR SHALL COMPLY AT ALL TIMES WITH APPLICABLE FEDERAL, STATE AND LOCAL LAWS, PROVISIONS AND POLICIES GOVERNING SAFETY AND HEALTH, INCLUDING THE FEDERAL CONSTRUCTION SAFETY ACT (PUBLIC LAW 91-54), FEDERAL REGISTER, CHAPTER XVII, PART 1926 OF TITLE 29 REGULATIONS, OCCUPATIONAL SAFETY AND HEALTH REGULATIONS FOR CONSTRUCTION AND SUBSEQUENT PUBLICATIONS UPDATING THESE REGULATIONS.
- 2. THE CONTRACTOR SHALL BE RESPONSIBLE FOR EXAMINING THE AREAS AND CONDITIONS UNDER WHICH THE PROJECT IS TO BE CONSTRUCTED PRIOR TO SUBMISSION OF A BID. SUBMISSION OF A BID SHALL MEAN THE CONTRACTOR HAS REVIEWED THE SITE AND IS FAMILIAR WITH CONDITIONS AND CONSTRAINTS OF THE SITE.
- 3. CUT SHEETS FOR ALL UNDERGROUND UTILITIES SHALL BE SUBMITTED TOGETHER IN ONE SUBMITTAL PRIOR TO ORDERING ANY UNDERGROUND MATERIALS OR APPURTENANCES.
- 4. ALL PRESUMED ERRORS OR DEFICIENCIES IN THE ENGINEERING DRAWINGS SHALL BE BROUGHT TO THE ATTENTION OF THE OWNER AS A PART OF THE OVERALL BID SUBMITTAL.
- 5. ALL PROPOSED SUBSTITUTIONS AND DEVIATIONS FROM THIS PLAN SET AND SPECIFICATIONS HAVE TO BE BROUGHT TO THE ATTENTION OF THE OWNER AS A PART OF THE BID SUBMITTAL.
- 6. ANY DAMAGE TO EXISTING MANHOLES, STRUCTURES, UTILITIES, FENCES, TILES, TRENCHES, PAVEMENTS, AND NOT CALLED OUT SPECIFICALLY IN THE PLANS SHALL BE REPAIRED OR REPLACED WITH EQUALS WITHOUT COST TO THE OWNER.
- 7. ALL PHASES OF THE PROPOSED IMPROVEMENTS ARE SUBJECT TO TESTING BY THE OWNER AND MUNICIPALITY. THE COST OF TESTS REQUIRED BY THESE AGENCIES OR PARTIES SHALL BE BORNE SOLELY BY THE CONTRACTOR AND THIS COST SHALL BE INCORPORATED INTO HIS PROPOSAL. IT SHALL BE THE RESPONSIBILITY OF THE CONTRACTOR TO DETERMINE FROM THE PARTIES AND AGENCIES INVOLVED WHAT TESTS ARE REQUIRED. THERE WILL BE NO EXTRAS AWARDED AS A RESULT OF THE CONTRACTOR CLAIMING IGNORANCE OF THE TESTING REQUIREMENTS FOR THIS PROJECT.
- 8. THE PROPOSED IMPROVEMENTS MUST BE CONSTRUCTED IN ACCORDANCE WITH THE ENGINEERING PLANS. THE CONSTRUCTION DETAILS, AS PRESENTED ON THESE PLANS MUST BE FOLLOWED BY THE CONTRACTOR. IMPROVEMENT REPRESENTATIONS AS SHOWN ON THESE PLANS ARE AS ACCURATE AS POSSIBLE FROM THE INFORMATION AVAILABLE. HOWEVER, SOME FIELD REVISIONS MAY BE REQUIRED TO ACCOMMODATE UNFORESEEN CIRCUMSTANCES. THE OWNER, MUNICIPALITY, AND ENGINEER SHALL BE ADVISED OF ANY NECESSARY REVISIONS WITH SUFFICIENT LEAD TIME ALLOWED TO PROPERLY CONSIDER AND ACT UPON SAID REQUESTS.
- 9. ALL RESTORATION OF EXISTING ROADWAYS, RIGHT-OF-WAYS OR PRIVATE PROPERTY ARE CONSIDERED INCIDENTAL TO THIS PROJECT WHERE NOT SPECIFICALLY CALLED OUT ON THE PLANS AND SHOULD BE INCLUDED IN THE COST OF THE PAVEMENT OR UNDERGROUND IMPROVEMENTS.
- 10. DURING CONSTRUCTION OPERATIONS, THE CONTRACTOR SHALL ENSURE POSITIVE SITE DRAINAGE AT THE CONCLUSION OF EACH DAY. SITE DRAINAGE MAY BE ACHIEVED BY DITCHING, PUMPING, OR ANY OTHER METHOD ACCEPTABLE TO THE OWNER. THE CONTRACTOR'S FAILURE TO PROVIDE THE ABOVE WILL PRECLUDE ANY POSSIBLE ADDED COMPENSATION REQUIRED DUE TO DELAYS OR UNSUITABLE MATERIALS CREATED AS A RESULT THEREOF.
- 11. WHENEVER, DURING CONSTRUCTION OPERATIONS, ANY LOOSE MATERIAL IS DEPOSITED IN THE FLOW LINE OF GUTTERS, DRAINAGE STRUCTURES, DITCHES, ETC..., SUCH THAT THE NATURAL FLOW LINE OF WATER IS OBSTRUCTED, THIS LOOSE MATERIAL SHALL BE REMOVED AT THE CLOSE OF EACH WORKING DAY. AT THE CONCLUSION OF CONSTRUCTION OPERATIONS, ALL DRAINAGE STRUCTURES AND FLOW LINES SHALL BE FREE FROM DIRT AND DEBRIS.
- 12. TRAFFIC CONTROL SHALL BE IN ACCORDANCE WITH THE APPLICABLE ARTICLES OF THE MINNESOTA DEPARTMENT OF TRANSPORTATION. NO MODIFICATIONS OF THESE REQUIREMENTS SHALL BE ALLOWED WITHOUT PRIOR WRITTEN APPROVAL OF THE ENGINEER. THE COST OF TRAFFIC CONTROL AND PROTECTION IS LIMITED TO THE CONTRACT AMOUNT.
- 13. AS PART OF THE BIDDING PROCEDURE, THE CONTRACTOR SHALL VERIFY THAT THE QUANTITIES FOR PAY ITEMS AS PRESENTED IN THESE PLAN DOCUMENTS ARE SUBSTANTIALLY CORRECT. IF DISCREPANCIES ARE DETECTED, THE CONTRACTOR SHALL NOTIFY THE OWNER, IN WRITING, OF THE DISCREPANCY PRIOR TO THE BID DATE.

- THESE UTILITY REPRESENTATIONS.

- GEOTECHNICAL INVESTIGATION REPORT.
- BORNE TOTALLY BY THE CONTRACTOR, WITH NO EXTRA COMPENSATION BEING AWARDED UNDER THIS CONTRACT.
- BUILDING DIMENSIONS AND EXACT BUILDING ENTRANCE LOCATIONS.
- ACCORDANCE WITH THE LATEST ADA STANDARDS.
- POND OUTLET IF NECESSARY.
- THE BID FOR THE UTILITY OR EARTHWORK.
- HIS OWN EARTHWORK COMPUTATIONS AND ANALYSES.
- EXPENSE

GRADING NOTES

1. BEFORE EXCAVATION, ALL UNDERGROUND UTILITIES, INCLUDING PIPELINES, SHALL BE LOCATED IN THE FIELD BY THE PROPER AUTHORITIES. THE LOCATION OF ALL UTILITIES AND UNDERGROUND STRUCTURES SHOWN ARE APPROXIMATE AND THOSE SHOWN ARE NOT NECESSARILY ALL OF THE EXISTING UTILITIES. IT IS THE RESPONSIBILITY OF THE CONTRACTOR TO VERIFY THE EXISTENCE, LOCATION, AND SIZE OF ALL UTILITIES AND UNDERGROUND STRUCTURES AND REPORT DISCREPANCIES TO THE ENGINEER PRIOR TO THE COMMENCEMENT OF WORK. THE ENGINEER AND OWNER ASSUME NO RESPONSIBILITY FOR THE ADEQUACY, ACCURACY, SUFFICIENCY OR EXACTNESS OF

2. ALL EXISTING STRUCTURES, UNLESS OTHERWISE NOTED TO REMAIN, FENCING, TREES, ETC., WITHIN CONSTRUCTION AREA SHALL BE REMOVED & DISPOSED OF OFF SITE.

3. SITE GRADING SHALL NOT PROCEED UNTIL EROSION CONTROL MEASURES ARE IN PLACE.

4. ALL EARTHWORK OPERATIONS SHALL BE IN STRICT CONFORMANCE WITH THE

5. A MINIMUM OF 6 INCHES OF TOPSOIL IS TO BE PLACED IN ALL DISTURBED AREAS WHICH WILL REMAIN UNPAVED. REMOVE ALL ORGANICS. ANY AREAS DAMAGED OR DESTROYED DURING THE PROJECT AS A DIRECT OR INDIRECT RESULT OF CONTRACTOR OPERATIONS SHALL BE RESTORED TO THAT CONDITION OR BETTER WHICH EXISTED PRIOR TO THE START OF CONSTRUCTION. THE COST OF SAID RESTORATION OR REPAIR SHALL BE

6. THE CONTRACTOR SHALL REFER TO ARCHITECTURAL PLANS FOR EXACT LOCATIONS AND DIMENSIONS OF ENTRANCES, VESTIBULES, STAIRS, RETAINING WALLS, RAMPS, PRECISE

7. SLOPES SHALL BE 3:1 (HORIZONTAL:VERTICAL) MAXIMUM UNLESS NOTED OTHERWISE.

8. PAVEMENT SLOPES ACROSS HANDICAP PARKING STALLS AND ADJOINING ACCESS AISLES SHALL BE A MAXIMUM OF 2% IN ALL DIRECTIONS, INCLUDING DIAGONALLY, OR IN

9. CONTRACTOR SHALL MAINTAIN POSITIVE DRAINAGE AT ALL TIMES THROUGH THE GRADING PROCESS TO AVOID LARGE POOLS OF STANDING WATER AND TO KEEP SITE WORK FUNCTIONING. THIS MAY INVOLVE THE INSTALLATION OF STORM PIPES AND THE

10. ALL SURPLUS EXCAVATED MATERIAL FROM THE EARTHWORK, UTILITY TRENCHES, FOUNDATION EXCAVATION, ETC... IS TO BE SPREAD OVER THE SITE IN LOCATIONS AS DIRECTED BY THE OWNER AND COMPACTED; OR HAULED OFF-SITE AS DIRECTED BY THE OWNER TO A MUTUALLY AGREED UPON LOCATION. THE COST OF MATERIAL TRANSPORTATION AND CONSTRUCTION OPERATIONS INVOLVED IN PERFORMING THIS ITEM SHALL BE CONSIDERED INCIDENTAL TO THE CONTRACT AND SHALL BE INCLUDED IN

11. EARTHWORK QUANTITIES AND ASSUMPTIONS ARE SHOWN IN THESE PLANS FOR COMPARISON PURPOSES ONLY. THE CONTRACTOR IS RESPONSIBLE FOR PERFORMING

12. CONTRACTOR TO INSTALL THE TEMPORARY CONSTRUCTION ENTRANCE AS SHOWN ON THE EROSION & SEDIMENT CONTROL SHEET AND RELATED DETAILS. IT IS ANTICIPATED THAT THE MATERIAL USED FOR THE TEMPORARY CONSTRUCTION ENTRANCE WILL NEED TO BE REMOVED AND THE UNDERLYING SOIL WILL NEED TO BE RE-COMPACTED. FAILURE TO PROVIDE POSITIVE DRAINAGE DURING CONSTRUCTION MAY RESULT IN UNSUITABLE SOILS THAT WILL NEED TO BE REMOVED AND REPLACED AT THE CONTRACTOR'S


UTILITY NOTES

1. GRANULAR TRENCH BACKFILL MATERIAL (ASTM D448 NO. 67 OR AS APPROVED BY THE ENGINEER) SHALL BE PLACED AND COMPACTED IN LIFTS IN ALL UTILITY AND SERVICE TRENCHES, (INCLUDING UNDERGROUND DETENTION FACILITIES WHEN PROPOSED), UNDER OR WITHIN (2) FEET OF PAVED SURFACES. THE BACKFILL SHALL EXTEND TO THE SUBGRADE OF THE PAVEMENT. UTILITY TRENCHES NOT UNDER OR WITHIN (2) FEET OF PAVED SURFACES SHALL BE BACKFILLED WITH EXISTING MATERIALS AS APPROVED BY THE ENGINEER. SHOULD UNSUITABLE MATERIAL BE ENCOUNTERED, THE CONTRACTOR SHALL SUBSTITUTE APPROVED MATERIALS AT NO ADDITIONAL COST.


- 2. IF PIPES ARE INSTALLED PRIOR TO MASS GRADING, RESULTING IN THE PLACEMENT OF SOIL ABOVE THE PREVIOUSLY CONSTRUCTED TRENCH, SAID SOIL MUST BE REMOVED AND REPLACED WITH GRANULAR TRENCH BACKFILL SUCH THAT THE GRANULAR TRENCH BACKFILL EXTENDS FROM THE PIPE BEDDING ALLTHE WAY TO THE SUBGRADE.
- 3. THERMOPLASTIC PIPE FOR SANITARY AND STORM SEWERS SHALL BE INSTALLED AND TESTED PER ALL SECTIONS OF ASTM D-2321. PVC WATERMAIN SHALL BE INSTALLED AND TESTED PER ALL SECTIONS OF AWWA C605.
- 4. SANITARY SEWER SHALL BE PVC SDR-26 PIPE CONFORMING TO ASTM D-3034 WITH ELASTOMERIC JOINTS PER ASTM D-3212. THE SEALING GASKET MUST CONFORM TO THE REQUIREMENTS OF ASTM F-477.
- 5. WATER MAINS SHALL BE PVC DR-14 PIPE CONFORMING TO AWWA C900, WITH JOINTS CONFORMING TO ASTM D-3139, AND THE JOINT GASKET SHALL CONFORM TO ASTM F-477. THE PIPE SHALL HAVE A MINIMUM COVER OF 5.5'.
- 6. STORM SEWER SHALL BE HDPE EXCEPT WHERE NOTED OTHERWISE. HDPE PIPE SHALL CONFORM TO ASTM D-3350. JOINTS SHALL MEET THE REQUIREMENTS OF ASTM D-3212 AND THE SEALING GASKET SHALL MEET THE REQUIREMENTS OF ASTM F-477.
- 7. RCP STORM SEWER SHALL CONFORM TO ASTM C 76 WITH RUBBER GASKET JOINTS CONFORMING TO ASTM C-443. THE REQUIRED CLASS OF PIPE SHALL BE AS INDICATED ON THE PLANS, OR CLASS IV IF NOT INDICATED.
- 8. THE PVC STORM SEWER ADJACENT TO THE BUILDING FOR DOWNSPOUT COLLECTION AND PVC STORM SEWER CALLED OUT AS "WATERMAIN QUALITY" SHALL BE DR-25 AND CONFORM TO AWWA C900, WITH JOINTS CONFORMING TO ASTM D-3139, AND THE JOINT GASKET SHALL CONFORM TO ASTM F-477. OTHER PVC STORM SEWER (4-15") SHALL BE SDR-35 PIPE CONFORMING TO ASTM D-3034 WITH ELASTOMERIC JOINTS PER ASTM D-3212. THE SEALING GASKET MUST CONFORM TO THE REQUIREMENTS OF ASTM F-477. PVC STORM SEWER 18" DIAMETER AND ABOVE SHALL MEET THE REQUIREMENTS OF ASTM F-679 WITH JOINTS PER ASTM D-3212.
- 9. CONTRACTOR SHALL COORDINATE THE INSTALLATION OF ALL PRIVATE UTILITIES, UTILITY FRANCHISE, TAP AND INSTALLATION. FEES REQUESTED FROM UTILITY PROVIDERS SHALL BE PAID FOR BY THE OWNER. CONTRACTOR TO FACILITATE PAYMENT AND PROGRESS.
- 10. 6" FIRE PROTECTION LINE IS ASSUMED FOR BIDDING PURPOSES. SITE CONTRACTOR TO COORDINATE WITH FIRE SPRINKLER DESIGNER PRIOR TO INSTALLATION.
- 11. ALL WATER FITTINGS (INCLUDING BENDS OR ELBOWS 11 1/4° AND GREATER), VALVES AND FIRE HYDRANTS SHALL INCLUDE RESTRAINED JOINTS OR CONCRETE THRUST BLOCKS.
- 12. WHENEVER POSSIBLE, A WATER MAIN SHOULD BE LAID AT LEAST TEN FEET HORIZONTALLY FROM ANY EXISTING OR PROPOSED DRAIN OR SEWER LINE.
- 13. SHOULD LOCAL CONDITIONS PREVAIL WHICH WOULD PREVENT A LATERAL SEPARATION OF TEN FEET, A WATER MAIN MAY BE LAID CLOSER THAN TEN FEET TO, OR IN THE SAME TRENCH AS, A STORM OR SANITARY SEWER, PROVIDED THE MAIN IS LAID IN A SEPARATE TRENCH OR ON AN UNDISTURBED EARTH SHELF LOCATED TO ONE SIDE OF THE SEWER AND AT SUCH AN ELEVATION THAT THE BOTTOM OF THE WATER MAIN IS AT LEAST EIGHTEEN INCHES ABOVE THE TOP OF THE SEWER. THIS DEVIATION MUST BE APPROVED IN WRITING BY THE CITY ENGINEER.
- 14. WHENEVER WATER MAINS OR SERVICES MUST CROSS STORM DRAINS OR SANITARY SEWERS, THE WATER MAIN SHOULD BE LAID AT SUCH AN ELEVATION THAT THE BOTTOM OF THE WATER MAIN IS EIGHTEEN INCHES ABOVE THE TOP OF THE DRAIN OR SEWER. THIS VERTICAL SEPARATION SHOULD BE MAINTAINED FOR THE PORTION OF THE WATER MAIN LOCATED WITHIN TEN FEET, HORIZONTALLY, OF ANY SEWER OR DRAIN CROSSED. SAID TEN FEET TO BE MEASURED AS THE NORMAL DISTANCE FROM THE WATER MAIN TO THE DRAIN OR SEWER.
- 15. WHERE CONDITIONS EXIST THAT THE MINIMUM VERTICAL SEPARATION DESCRIBED ABOVE CANNOT BE MAINTAINED, OR IT IS NECESSARY FOR THE WATER MAIN TO PASS UNDER A SEWER OR DRAIN, THE SEWER MAIN SHOULD BE OF WATER MAIN QUALITY MATERIAL (DUCTILE IRON OR PVC PIPE CONFORMING TO AWWA C900 WITH JOINTS CONFORMING TO ASTM D-3139).
- 16. ANY EXISTING UTILITY STRUCTURES REQUIRING ADJUSTMENT ARE TO BE ADJUSTED (UP TO 8" TOTAL ADJUSTMENT) OR RECONSTRUCTED BY THE CONTRACTOR. ADJUSTMENTS OR RECONSTRUCTIONS NOT CALLED FOR ON THE PLANS SHALL BE CONSIDERED INCIDENTAL TO THE CONTRACT.
- 17. ALL EXISTING FIELD DRAINAGE TILES ENCOUNTERED OR DAMAGED DURING CONSTRUCTION ARE TO BE RESTORED TO THEIR ORIGINAL CONDITION, PROPERLY REROUTED AND/OR CONNECTED TO THE STORM SEWER SYSTEM IN A MANNER DEEMED APPROPRIATE BY THE CITY ENGINEER.

	13747 MONTFORT DR SUITE 275
CONCRETE PAVING NOTES	DALLAS, TX 75240 214-678-9968
 MIXES SHALL BE DESIGNED TO PROVIDE CONCRETE IN COMPLIANCE WITH ASTM C94 WITH A 4,000 PSI (CLASS A) COMPRESSIVE STRENGTH AT 28 DAYS. MIX SHOULD BE DESIGNED WITH 4-6% AIR ENTRAINMENT. 	PREPARED FOR: REESE REAL ESTATE DEVELOPMENT
 PORTLAND CEMENT SHALL BE A SINGLE BRAND CONFORMING TO ASTM C-150, TYPE 1, UNLESS OTHERWISE APPROVED. 	PARTNERS
 NORMAL WEIGHT AGGREGATES SHALL CONFORM TO ASTM C-33. THE MAXIMUM SIZE OF COARSE AGGREGATE SHALL BE THE FOLLOWING: PAVEMENT = 1" 	1076 SUMMIT DRIVE MIDDLETOWN, OHIO 45042
4. ADDITIVES FOR AIR ENTRAINMENT, WATER REDUCTION, AND SET CONTROL SHALL BE USED IN ACCORDANCE WITH THE MANUFACTURER'S DIRECTIONS, AND APPROVED BY ENGINEER.	(513) 849-8015
 SLUMP SHALL NOT EXCEED 5" FOR PAVEMENTS PLACED BY METHODS OTHER THAN SLIPFORM EQUIPMENT OR 1-1/2" FOR CONCRETE PLACED WITH SLIPFORM EQUIPMENT. 	
 SPRAY WHITE PIGMENTED MEMBRANE-FORMING CURING COMPOUNDS MEETING ASTM C309, TYPE 2, CLASS A DIRECTLY AFTER FINISHING. 	PRELIMINARY - FOR REVIEW ONLY THESE DOCUMENTS ARE FOR DESIGN REVIEW AND NOT INTENDED FOR CONSTRUCTION,
 STEEL REINFORCING BARS SHALL CONFORM TO ASTM A-615. NO. 3 AND LARGER BARS SHALL BE GRADE 60. 	BIDDING OR PERMIT PURPOSES. THEY WERE PREPARED BY, OR UNDER SUPERVISION OF: MATT GAUNTT 61596 8/16/23
8. MILD STEEL REINFORCEMENT SHALL BE PLACED AND SECURED IN ACCORDANCE WITH CRSI "RECOMMENDED PRACTICE FOR PLACING REINFORCING BARS".	TYPE OR PRINT NAME PE # DATE
9. REINFORCING STEEL WILL NOT BE ACCEPTED WITHOUT APPROPRIATE CHAIRING. BRICK CHAIRS ARE <u>NOT</u> ACCEPTABLE. MANUFACTURED PLASTIC REBAR CHAIRING THAT ARE ADEQUATE IN STRENGTH AND NUMBER TO PREVENT DISPLACEMENT OF REINFORCING STEEL SHALL BE USED. CHAIR SUPPORTS SHALL BE PLACED PER MANUFACTURER'S RECOMMENDATION, BUT SHALL NOT IN ANY CASE EXCEED A MAXIMUM OF 4-FT EACH DIRECTION.	PROJECT NOTES:
10. ALL SLOPES WITHIN ACCESSIBLE PARKING AREAS SHALL NOT EXCEED 2.0% IN ALL DIRECTIONS. ALL SLOPES ALONG ACCESSIBLE ROUTES SHALL NOT EXCEED 5.0% LONGITUDINALLY AND 2.0% IN CROSS-SLOPE.	
11. CONTRACTOR SHALL ENSURE COMPLIANCE WITH ALL TAS STANDARDS FOR ACCESSIBILITY. DISCREPANCIES BETWEEN THE PLANS AND TAS STANDARDS SHALL DEFER TO TAS REQUIREMENTS. NOTIFY ENGINEERING IN THE EVENT OF A DISCREPANCY.	
12. FAULTY CONCRETE PAVING WORKMANSHIP INCLUDING, BUT NOT LIMITED TO, BIRD BATHS, RAVELING, SPALLING, SCALING, EARLY AND/OR EXTREME CRACKING, ETC. SHALL BE REMOVED BY SAWCUTTING ENTIRE EFFECTED PANEL FROM NEAREST CONTRACTION AND/OR EXPANSION JOINTS. REPLACEMENT SHALL INCORPORATE APPROPRIATE DOWELING AND REINFORCEMENT PER PLAN DETAILS	
	BENCHMARK 1: HYDRANT - TNH ELEVATION: 924.27' N: 186414.14 E: 483352.17 BENCHMARK 2: HYDRANT - TNH ELEVATION: 928.93' N: 185882.21 E: 483286.41 BENCHMARK 3: HYDRANT - TNH ELEVATION: 929.07' N: 185704.53 E: 783567.81 BENCHMARK 4: HYDRANT - TNH ELEVATION: 927.66' N: 186124.24 E: 483927.22 No. DATE BY DESCRIPTION
	REESE DEV - TSC PROJECT ADDRESS DUNDAS, MN
	GENERAL NOTES PROJECT NUMBER: 03-217-003 DATE: SCALE: 8/16/23 NTS DRAFTED BY: SHEET No. DESIGNED BY: BML CHECKED BY: OF 18 SHEETS

PREPARED BY:

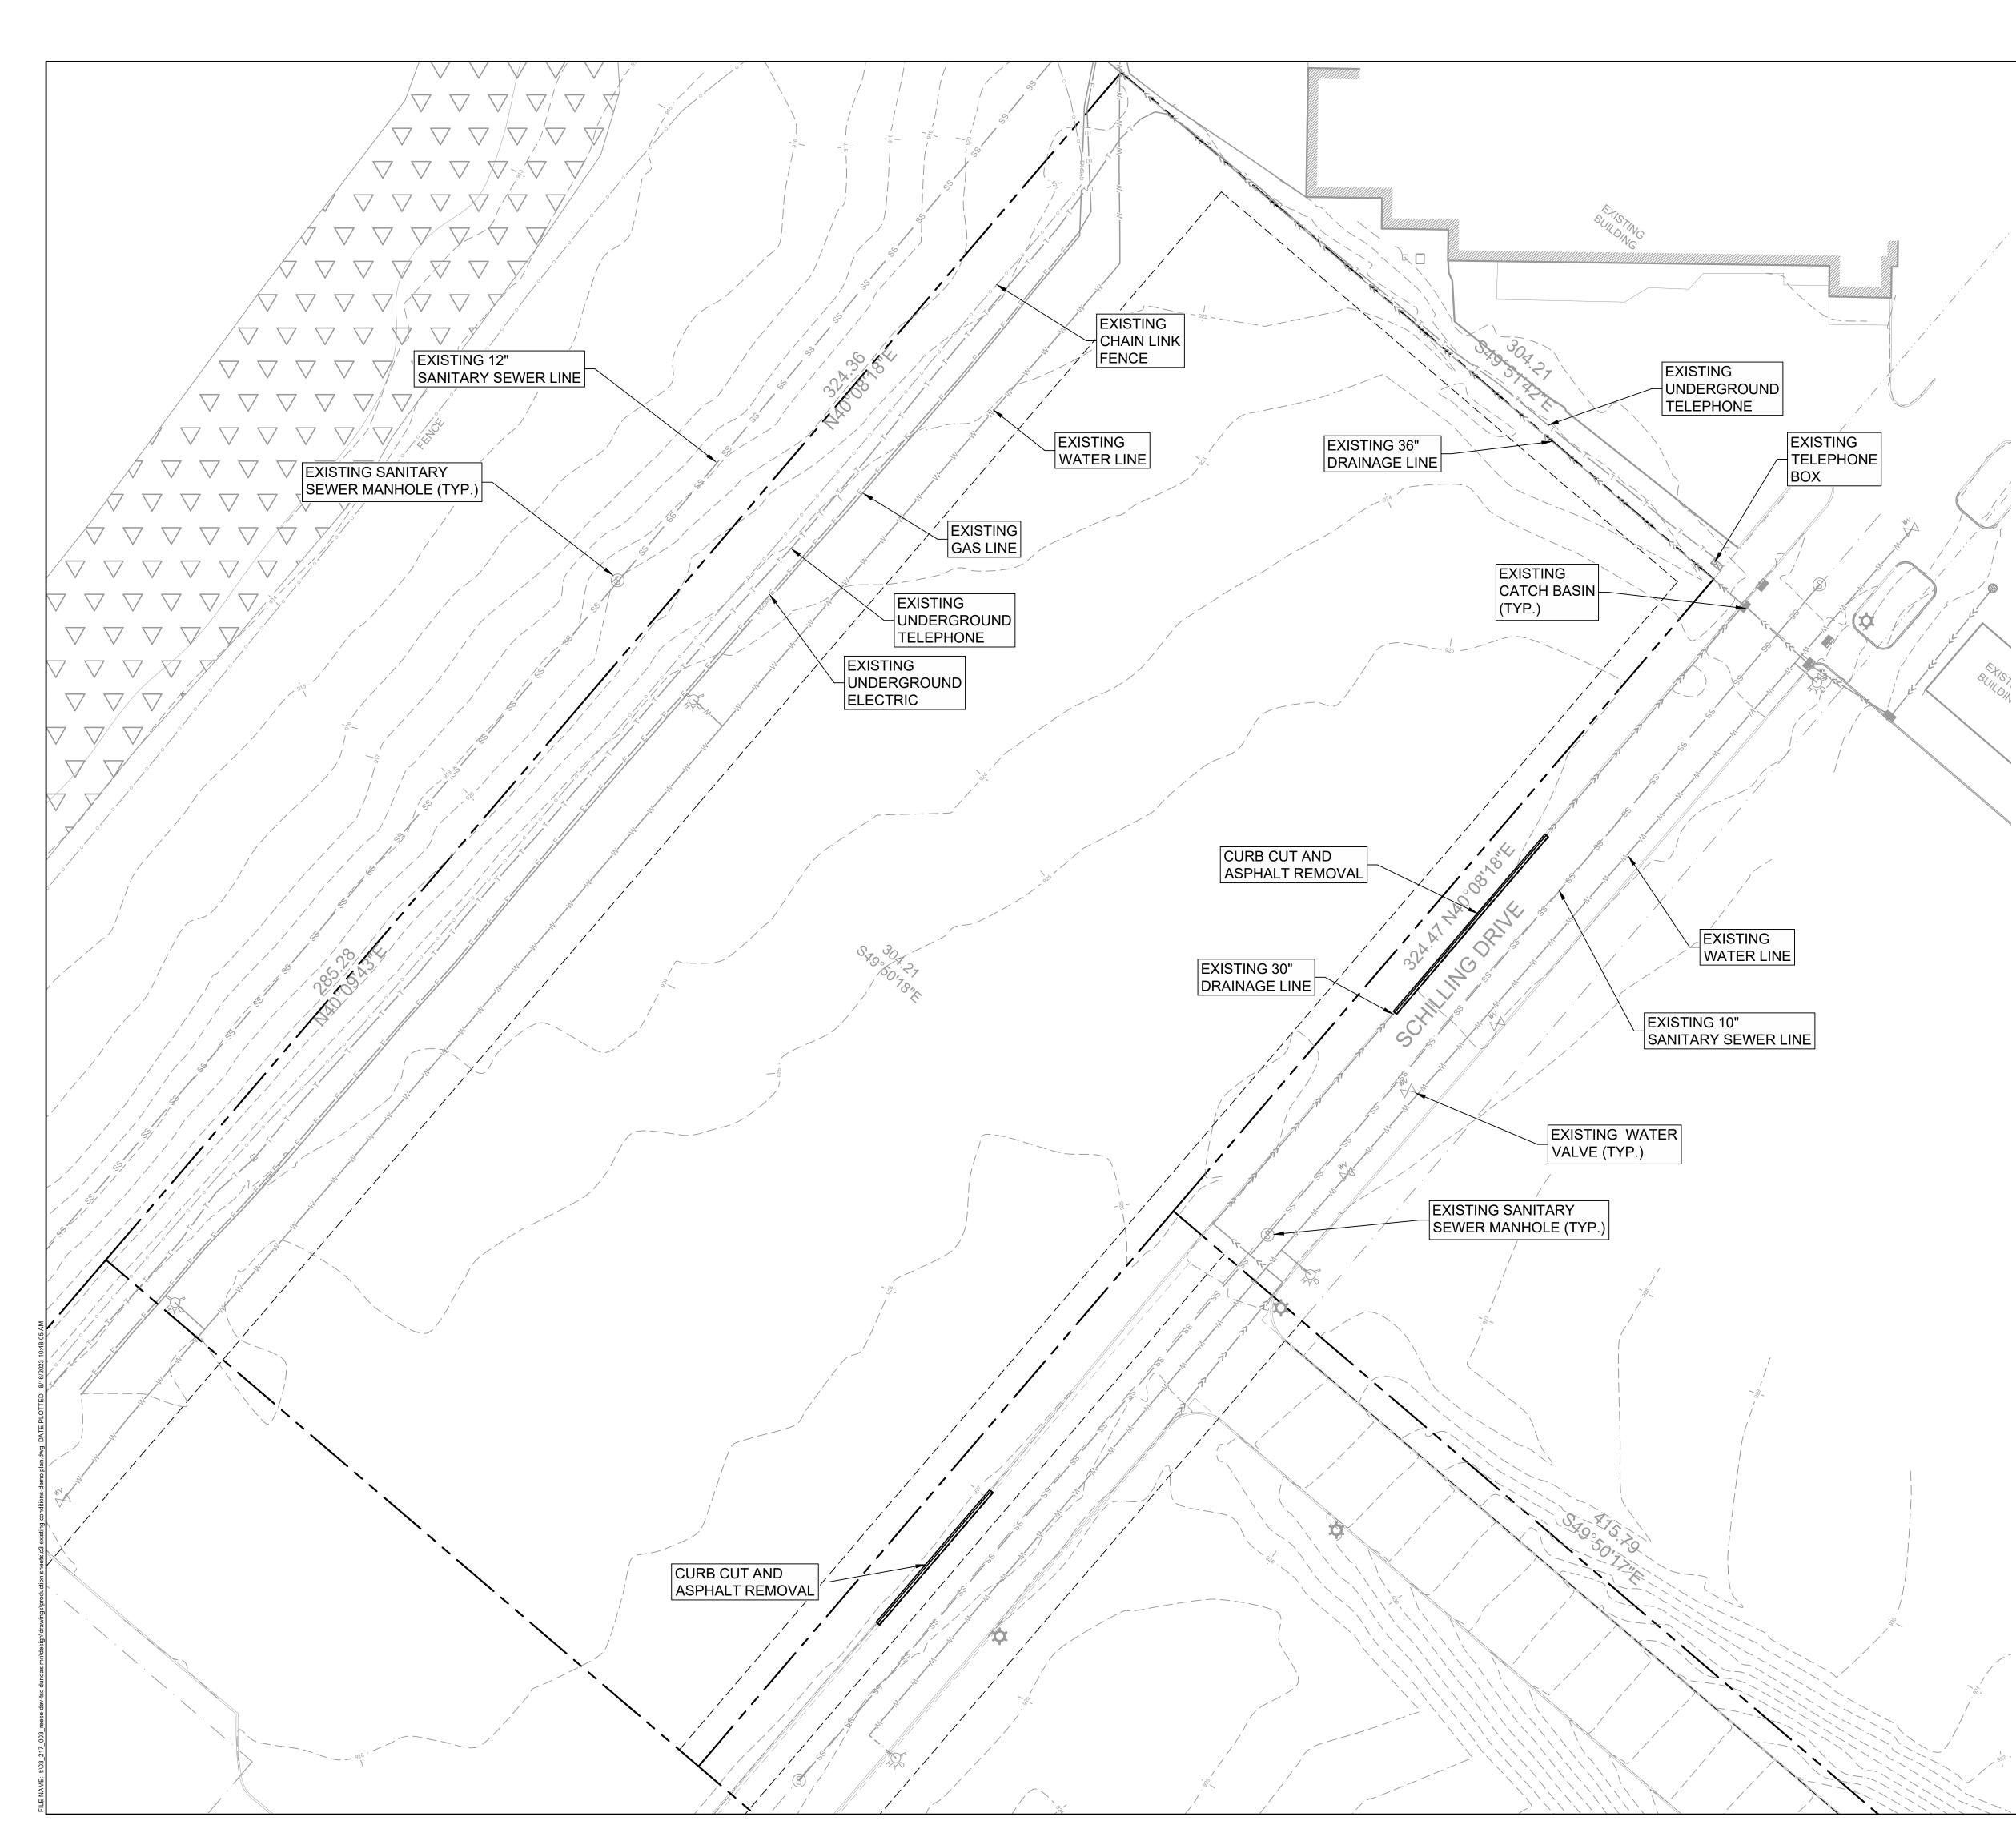

	PREPARED BY:
Ňı	13747 MONTFORT DR SUITE 275
	DALLAS, TX 75240
	214-678-9968
0 30' 60'	PREPARED FOR:
	REESE REAL ESTATE
LECEND	DEVELOPMENT
LEGEND	PARTNERS
BOUNDARY LINE	1076 SUMMIT DRIVE
	MIDDLETOWN, OHIO 45042
PARKING / BUILDING SETBACK LINE SAW CUT LIMITS	(513) 849-8015
	PRELIMINARY - FOR REVIEW ONLY
	THESE DOCUMENTS ARE FOR DESIGN REVIEW AND NOT INTENDED FOR CONSTRUCTION,
	BIDDING OR PERMIT PURPOSES. THEY WERE PREPARED BY, OR UNDER SUPERVISION OF:
	MATT GAUNTT 61596 8/16/23 TYPE OR PRINT NAME PE # DATE
	PROJECT NOTES:
	BENCHMARKS:
	BENCHMARK 1:
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	REVISIONS / ISSUANCES
	No. DATE BY DESCRIPTION
	REESE DEV - TSC
	PROJECT ADDRESS
	DUNDAS, MN
	EXISTING
	CONDITIONS-DEMO
Know what's below .	PLAN
Call before you dig.	
	PROJECT NUMBER: 03-217-003
	DATE: SCALE:
GOPHER STATE ONE	8/16/23 1"=30' DRAFTED BY:
48 HOURS BEFORE YOU DIG	BML SHEET No.
CALL 811 OR 800-252-1166)) BML C3
	CHECKED BY: OF 18 SHEETS MAG

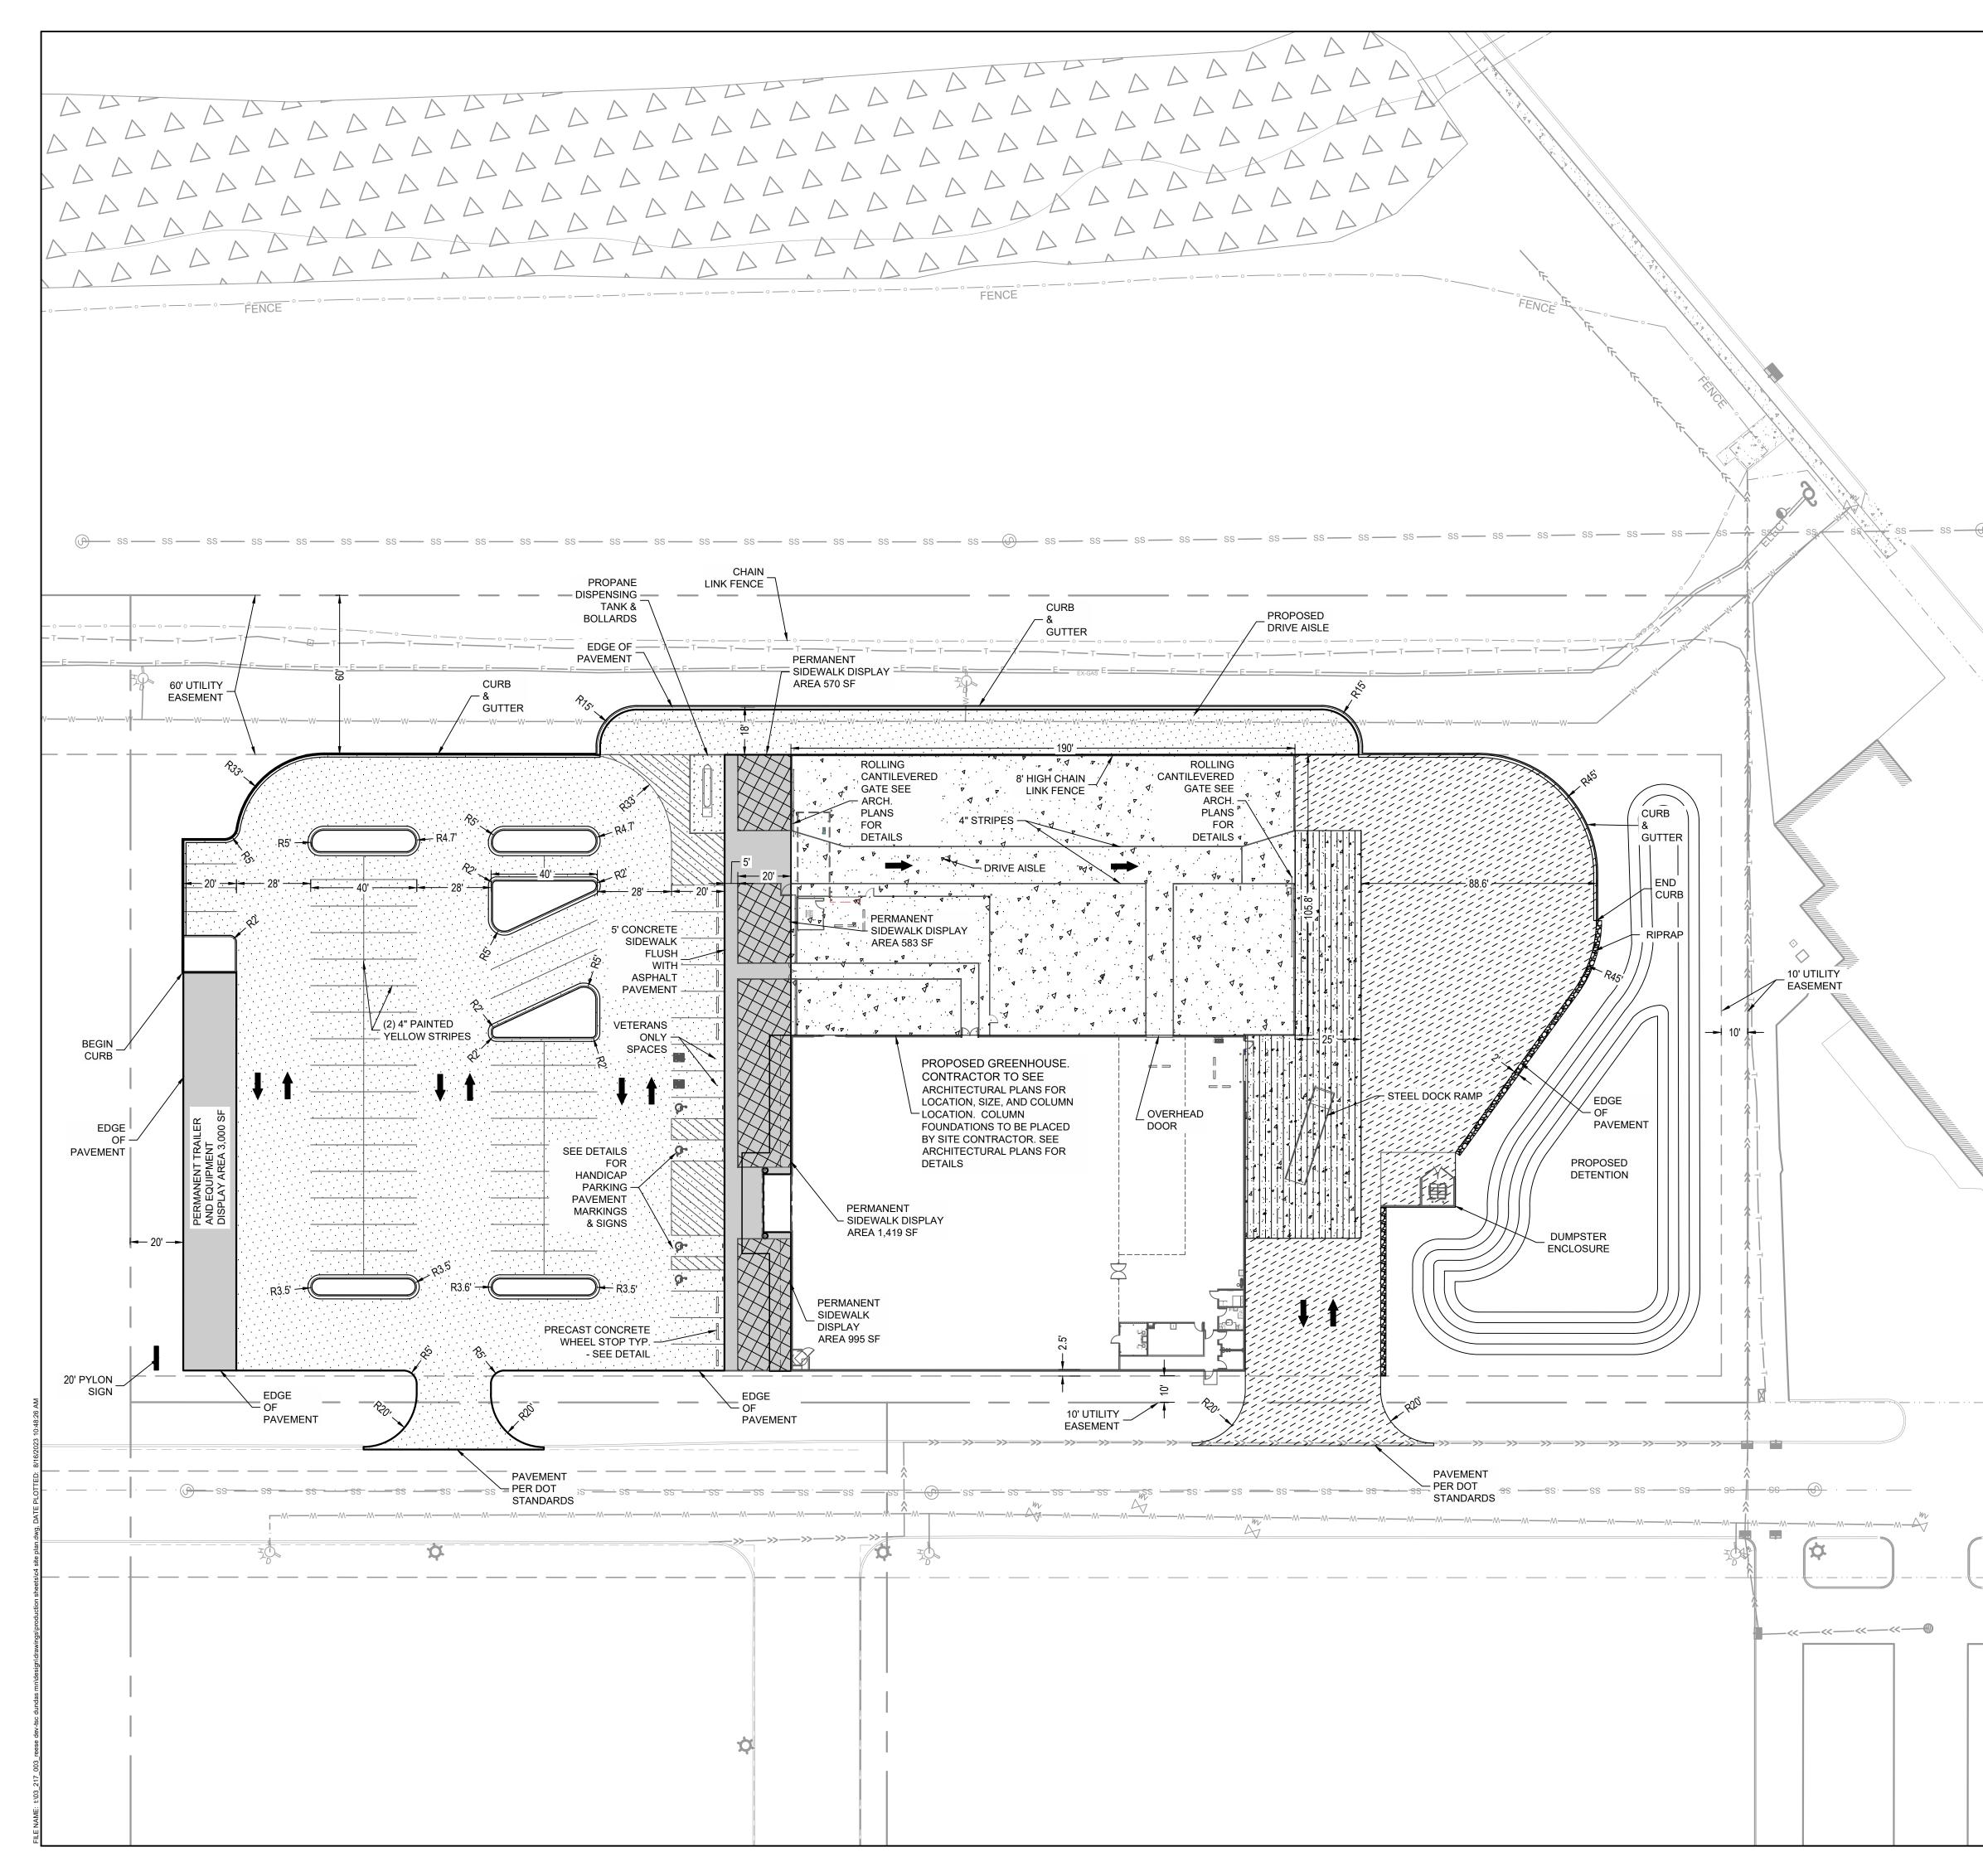

	PREPA	RED BY:
	13747 MON SUIT DALLAS,	NTFORT DR E 275 TX 75240 78-9968
0 30' 60' LEGEND	REESE REA DEVELO	RED FOR: AL ESTATE OPMENT 'NERS
BOUNDARY LINE EASEMENT LINE PARKING / BUILDING SETBACK LINE PROPOSED LIGHT POLE & FIXTURE(S) PROPOSED SIGN	MIDDLETOW	IMIT DRIVE N, OHIO 45042 49-8015
LIGHT DUTY CONCRETE PAVEMENT HEAVY DUTY CONCRETE PAVEMENT RMANENT SIDEWALK DISPLAY AREA SIDEWALK PAVEMENT HEAVY DUTY ASPHALT PAVEMENT LIGHT DUTY ASPHALT PAVEMENT	PRELIMINARY - FO THESE DOCUMENTS ARE AND NOT INTENDED FOR BIDDING OR PERMIT PUR PREPARED BY, OR UNDE MATT GAUNTT TYPE OR PRINT NAME	FOR DESIGN REVIEW CONSTRUCTION, RPOSES. THEY WERE
NOTE: PAVEMENT TO BE CONSTRUCTED TO THE APPLICABLE PAVEMENT SECTIONS IN THE CONSTRUCTION DETAILS	PROJEC	T NOTES:
 NOTES: LIGHTING LOCATIONS ARE SHOWN FOR ILLUSTRATIVE PURPOSES ONLY. REFER TO ELECTRICAL PLANS TO CONFIRM LOCATIONS AND FOR PHOTOMETRIC VALUES. STRIPING ON CONCRETE TO BE YELLOW AND STRIPING ON ASPHALT TO BE WHITE. DIMENSIONS ARE SHOWN TO FACE OF CURB. DETECTABLE WARNING SURFACES (TRUNCATED DOMES) SHALL CONTRAST VISUALLY WITH AD JACENT WALKING 		
SHALL CONTRAST VISUALLY WITH ADJACENT WALKING SURFACES - EITHER LIGHT-ON-DARK, OR DARK-ON-LIGHT.	BENCH	MARKS:
 PARKING LOT PAINT SPECIFICATIONS - 15 MIL APPLICATION (0.015 INCH THICKNESS): NEW PAVEMENT SURFACE TO CURE FOR A PERIOD OF NOT LESS THAN 14 DAYS BEFORE APPLICATION OF MARKING MATERIALS. REMOVE ALL DIRT, GRAVEL, DEBRIS, VEGETATION, OR OTHER MISCELLANEOUS OBJECTS FROM THE SURFACE WITH A BROOM TRUCK OR EQUIVALENT RIGOROUS METHOD. PROVIDE A CLEAN, DUST-FREE AND COMPLETELY DRY SURFACE FOR PAINT APPLICATION. DO NOT APPLY PAINT OVER EXISTING TAPE MARKINGS. CONFIRM & RECORD PROPER AIR AND SURFACE TEMPERATURES OF 55° AND RISING AND LESS THAN 95°. IF THE SURFACE TEMPERATURE IS NOT WITHIN THE TEMPERATURE RANGE OR IF THE PAINT APPLICATION IS DONE UNDER ADVERSE CONDITIONS (AS DETERMINED BY THE CONSTRUCTION PROJECT MANAGER) SUCH AS ABOVE 75% HUMIDITY, NIGHT STRIPING, ETC. IN ORDER TO MEET TSC OPENING SCHEDULE, CONTRACTOR TO RE-SCHEDULE AND COMPLETE SURFACE STRIPING UNDER PROPER CONDITIONS A MINIMUM OF 30 DAYS PRIOR TO THE EXPIRATION OF THE (1) ONE YEAR CONSTRUCTION WARRANTY. PROVIDE A 15 MIL THICK 4" WIDE CONTINUOUS STRIPE WHERE AND IN THE COLOR INDICATED, MINIMUM OF (2) TWO COATS. PROVIDE PRIMER AND SEALER TO BE APPLIED PER THE MANUFACTURER'S RECOMMENDATIONS ON ALL CONCRETE SURFACES AND ON ASPHALT SURFACES THAT ARE MORE THAN TWO YEARS OLD, 	HYDRAI ELEVATIO N: 1 E: 4 BENCH HYDRAI ELEVATIO N: 1 E: 4 BENCH HYDRAI ELEVATIO N: 1 E: 7 BENCH HYDRAI ELEVATIO N: 1 N: 1 N: 1 N: 1 N: 1 N: 1 N: 1 N: 1	MARK 1: NT - TNH DN: 924.27' 86414.14 183352.17 MARK 2: NT - TNH DN: 928.93' 185882.21 183286.41 MARK 3: NT - TNH DN: 929.07' 85704.53 783567.81 MARK 4: NT - TNH DN: 927.66' 86124.24 183927.22
 OXIDIZED AND/OR HAVE AGGREGATE EXPOSED. SEE ARCHITECTURAL PLANS FOR VETERAN AND ON-LINE ORDER PARKING SPACES. 	No. DATE BY	DESCRIPTION
PARKING SUMMARY70REGULAR SPACES4HANDICAPPED SPACES(Including 1 van accessible space)74TOTAL SPACES PROVIDED	REESE D PROJECT DUNDA	
	SITE	PLAN
	PROJECT NUMBER: DATE: 8/16/23 DRAFTED BY: BML	03-217-003 SCALE: 1"=30' SHEET No.
	DESIGNED BY: BML CHECKED BY: MAG	OF 18 SHEETS






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PROPOSED CONTOURS Image: marked status EXISTING CONTOURS Image: marked status DRAINAGE FLOW / DITCH LINE Image: marked status DRAINAGE FLOW / DITCH LINE Image: marked status ELEVATION SPOT SHOTS: Image: marked status TC = TOP OF CURB TP = TOP OF PAVEMENT EP = EDGE OF PAVEMENT FL = FLOW LINE BIDDING OR PERMIT PRELIMINARY - FOR F FF = FLOW LINE BIDDING OR PERMIT FURPOSE PROPOSED BY, OR UNDER SU MATTENDED FOR COM MATTENDED FOR COM BIDDING OR PERMIT FURPOSE PROJECT NO HP = HIGH POINT LP = LOW POINT TW = TOP OF WALL FG = FINISHED GRADE GRADING NOTESS 1 ALL EXISTING STRUCTURES, UNLESS OTHERWISE NOTED TO REMAIN, FENCING, TREES, ETC., WITHIN CONSTRUCTION AREA SHALL BE REMOVED & DISPOSED OF OF FSITE. ANY BURNING ON SITE SHALL BE SUBJECT TO LOCAL ORDINANCES. 2. GENERAL CONTRACTOR SHALL NOTIFY ALL UTILITY COMPANIES HAVING UNDERGROUND UTILITIES ON SITE OR IN RIGHT-OF-WAY PRIOR TO EXCAVAT	OHIO 45042 8015 REVIEW ONLY R DESIGN REVIEW NSTRUCTION, SES. THEY WERE JPERVISION OF: 196 8/16/23 E # DATE
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REPORT.	K 1:
5. A MINIMUM OF 6 INCHES OF TOPSOIL IS TO BE PLACED IN ALL DISTURBED AREAS. THE PROPOSED ELEVATIONS ARE FINISHED GRADES. A MINIMUM OF SIX INCHES (6") OF TOPSOIL IS TO BE PLACED BEFORE FINISHED GRADE FLEVATIONS ARE ACHIEVED BENCHMARK	24.27' 4.14 2.17 K 2:
6. THE CONTRACTOR SHALL REFER TO ARCHITECTURAL PLANS FOR EXACT LOCATIONS AND DIMENSIONS OF ENTRANCES, VESTIBULES, STAIRS, RETAINING WALLS, RAMPS, PRECISE BUILDING DIMENSIONS AND EXACT BUILDING ENTRANCE LOCATIONS.	28.93' 2.21 6.41 K 3: FNH
N: 185704 F. THE CONTRACTOR SHALL COMPLY AT ALL TIMES WITH APPLICABLE FEDERAL, STATE AND LOCAL LAWS, PROVISIONS BENCHMARK AND POLICIES GOVERNING SAFETY AND HEALTH, INCLUDING THE HYDRANT - TH FEDERAL CONSTRUCTION SAFETY ACT (PUBLIC LAW 91-54), ELEVATION: 927 FEDERAL REGISTER, CHAPTER XVII, PART 1926 OF TITLE 29 N: 186124 E: 483927 H83927 REGULATIONS, OCCUPATIONAL SAFETY AND HEALTH E: 483927 PUBLICATIONS UPDATING THESE REGULATIONS. PUBLICATIONS. PUBLICATIONS.	7.81 K 4: FNH 27.66' 4.24
8. THE CONTRACTOR SHALL BE RESPONSIBLE FOR EXAMINING THE AREAS AND CONDITIONS UNDER WHICH THE PROJECT IS TO BE CONSTRUCTED PRIOR TO SUBMISSION OF A BID. SUBMISSION OF A BID SHALL MEAN THE CONTRACTOR HAS REVIEWED THE SITE AND IS FAMILIAR WITH CONDITIONS AND CONSTRAINTS OF THE SITE.	BUANCES DESCRIPTION
9. ALL SLOPES SHALL BE 3:1 (HORIZONTAL:VERTICAL) MAXIMUM UNLESS NOTED OTHERWISE.	
10. PAVEMENT SLOPES ACROSS HANDICAP PARKING STALLS AND ADJOINING ACCESS AISLES SHALL BE A MAXIMUM OF 2% IN ALL DIRECTIONS, OR IN ACCORDANCE WITH THE LATEST ADA STANDARDS.	
11. ALL AREAS NOT PAVED SHALL BE LANDSCAPED IN ACCORDANCE WITH THE LANDSCAPING NOTES ON ARCHITECTURAL PLAN SHEET AS-1, UNLESS NOTED OTHERWISE IN THE CONSTRUCTION DRAWINGS, SITE SPECIFICATIONS OR INSTRUCTED BY THE DEVELOPER.	
12. RESTORATION WITHIN THE STATE ROW SHALL BE IN ACCORDANCE WITH DOT STANDARD SPECIFICATIONS. PROJECT ADD	
13. THE DETENTION BASIN SHALL BE SEEDED WITH WETLAND SEED DUNDAS, MIXES.	
14. CONTRACTOR SHALL MAINTAIN POSITIVE DRAINAGE AT ALL TIMES THROUGH THE GRADING PROCESS TO AVOID LARGE POOLS OF STANDING WATER AND TO KEEP SITE WORK FUNCTIONING. THIS MAY INVOLVE THE INSTALLATION OF STORM PIPES AND THE POND OUTLET IF NECESSARY.	
GRADING	PLAN
PROJECT NUMBER:	03-217-003
DATE: 8/16/23	SCALE: 1"=30'
DRAFTED BY: BML	SHEET No.
DESIGNED BY: BML	<i>C</i> 5
CHECKED BY: MAG	OF 18 SHEETS





LEGEND	60'	13747 MON SUITE DALLAS, 214-673 PREPAR REESE REA DEVELC PART	TFORT DR 275 TX 75240 8-9968 ED FOR: LESTATE PMENT NERS
<u>LEGEND</u>	PROPOSED		MIT DRIVE N, OHIO 45042 9-8015
BOUNDARY LINE - - SS SANITARY SEWER = - W WATERMAIN - ·E E ELECTRIC - ·G G GAS - ·T TELEPHONE - -	——————————————————————————————————————	PRELIMINARY - FO THESE DOCUMENTS ARE AND NOT INTENDED FOR BIDDING OR PERMIT PURI PREPARED BY, OR UNDER MATT GAUNTT TYPE OR PRINT NAME	FOR DESIGN REVIEW CONSTRUCTION, POSES. THEY WERE
		PROJECT	NOTES:
<section-header><section-header><section-header><section-header><section-header><section-header><section-header></section-header></section-header></section-header></section-header></section-header></section-header></section-header>		E: 48 BENCHN HYDRAN ELEVATIO N: 18 E: 48 BENCHN HYDRAN ELEVATIO N: 18 E: 78 BENCHN HYDRAN ELEVATIO N: 18	MARK 1: T - TNH N: 924.27' 36414.14 33352.17 MARK 2: T - TNH N: 928.93' 35882.21 33286.41 MARK 3: T - TNH N: 929.07' 35704.53 33567.81 MARK 4: T - TNH
AR TRENCH BACKFILL MATERIAL (ASTM D448 NO. 67 OR AS APPROVED BY THE ENGIN IPACTED IN LIFTS IN ALL UTILITY AND SERVICE TRENCHES, (INCLUDING UNDERGROU OPOSED), UNDER OR WITHIN (2) FEET OF PAVED SURFACES. THE BACKFILL SHALL I AVEMENT. UTILITY TRENCHES NOT UNDER OR WITHIN (2) FEET OF PAVED SURFACE STING MATERIALS AS APPROVED BY THE ENGINEER. SHOULD UNSUITABLE MATERIA CTOR SHALL SUBSTITUTE APPROVED MATERIALS AT NO ADDITIONAL COST.	JND DETENTION FACILITIES EXTEND TO THE SUBGRADE ES SHALL BE BACKFILLED	REVISIONS / I	SSUANCES
ARE INSTALLED PRIOR TO MASS GRADING, RESULTING IN THE PLACEMENT OF SOL A JCTED TRENCH, SAID SOIL MUST BE REMOVED AND REPLACED WITH GRANULAR TRE NULAR TRENCH BACKFILL EXTENDS FROM THE PIPE BEDDING ALLTHE WAY TO THE S PLASTIC PIPE FOR SANITARY AND STORM SEWERS SHALL BE INSTALLED AND TESTE 2321. PVC WATERMAIN SHALL BE INSTALLED AND TESTED PER ALL SECTIONS OF AW Y SEWER SHALL BE PVC SDR-26 PIPE CONFORMING TO ASTM D-3034 WITH ELASTOM THE SEALING GASKET MUST CONFORM TO THE REQUIREMENTS OF ASTM F-477. IAINS SHALL BE PVC DR-14 PIPE CONFORMING TO AWWA C900, WITH JOINTS CONFOI T GASKET SHALL CONFORM TO ASTM F-477. THE PIPE SHALL HAVE A MINIMUM COVI CTOR SHALL COORDINATE THE INSTALLATION OF ALL PRIVATE UTILITIES, UTILITY FR TION. FEES REQUESTED FROM UTILITY PROVIDERS SHALL BE PAID FOR BY THE OW TE PAYMENT AND PROGRESS.	ENCH BACKFILL SUCH THAT SUBGRADE. ED PER ALL SECTIONS OF /WA C605. ERIC JOINTS PER ASTM RMING TO ASTM D-3139, AND ER OF 5.5'.	REESE D	
ROTECTION LINE IS ASSUMED FOR BIDDING PURPOSES. SITE CONTRACTOR TO COO ER DESIGNER PRIOR TO INSTALLATION. ER FITTINGS (INCLUDING BENDS OR ELBOWS 11 1/4° AND GREATER), VALVES AND FIL RESTRAINED JOINTS OR CONCRETE THRUST BLOCKS. ER POSSIBLE, A WATER MAIN SHOULD BE LAID AT LEAST TEN FEET HORIZONTALLY F ED DRAIN OR SEWER LINE. LOCAL CONDITIONS PREVAIL WHICH WOULD PREVENT A LATERAL SEPARATION OF T AID CLOSER THAN TEN FEET TO, OR IN THE SAME TRENCH AS, A STORM OR SANITAL	RE HYDRANTS SHALL FROM ANY EXISTING OR FEN FEET, A WATER MAIN RY SEWER, PROVIDED THE	PROJECT A DUNDA	ADDRESS
AID IN A SEPARATE TRENCH OR ON AN UNDISTURBED EARTH SHELF LOCATED TO OUUCH AN ELEVATION THAT THE BOTTOM OF THE WATER MAIN IS AT LEAST EIGHTEEN ER. THIS DEVIATION MUST BE APPROVED IN WRITING BY THE CITY ENGINEER. ER WATER MAINS OR SERVICES MUST CROSS STORM DRAINS OR SANITARY SEWER BE LAID AT SUCH AN ELEVATION THAT THE BOTTOM OF THE WATER MAIN IS EIGHTED RAIN OR SEWER. THIS VERTICAL SEPARATION SHOULD BE MAINTAINED FOR THE PO WITHIN TEN FEET, HORIZONTALLY, OF ANY SEWER OR DRAIN CROSSED. SAID TEN MAL DISTANCE FROM THE WATER MAIN TO THE DRAIN OR SEWER.	I INCHES ABOVE THE TOP OF S, THE WATER MAIN EN INCHES ABOVE THE TOP ORTION OF THE WATER MAIN	UTILITY	Z PLAN
MAL DISTANCE FROM THE WATER MAIN TO THE DRAIN OR SEWER. CONDITIONS EXIST THAT THE MINIMUM VERTICAL SEPARATION DESCRIBED ABOVE C. ESSARY FOR THE WATER MAIN TO PASS UNDER A SEWER OR DRAIN, THE SEWER M/ ALITY MATERIAL (DUCTILE IRON OR PVC PIPE CONFORMING TO AWWA C900 WITH JO	AIN SHOULD BE OF WATER	PROJECT NUMBER: DATE: 8/16/23 DRAFTED BY:	03-217-003 SCALE: 1"=30'
TING UTILITY STRUCTURES REQUIRING ADJUSTMENT ARE TO BE ADJUSTED (UP TO RUCTED BY THE CONTRACTOR. ADJUSTMENTS OR RECONSTRUCTIONS NOT CALLE CONSIDERED INCIDENTAL TO THE CONTRACT.		DRAFTED BY: BML DESIGNED BY: BML CHECKED BY: MAG	SCALE: 1"=30' SHEET No. C6 OF 18 SHEETS

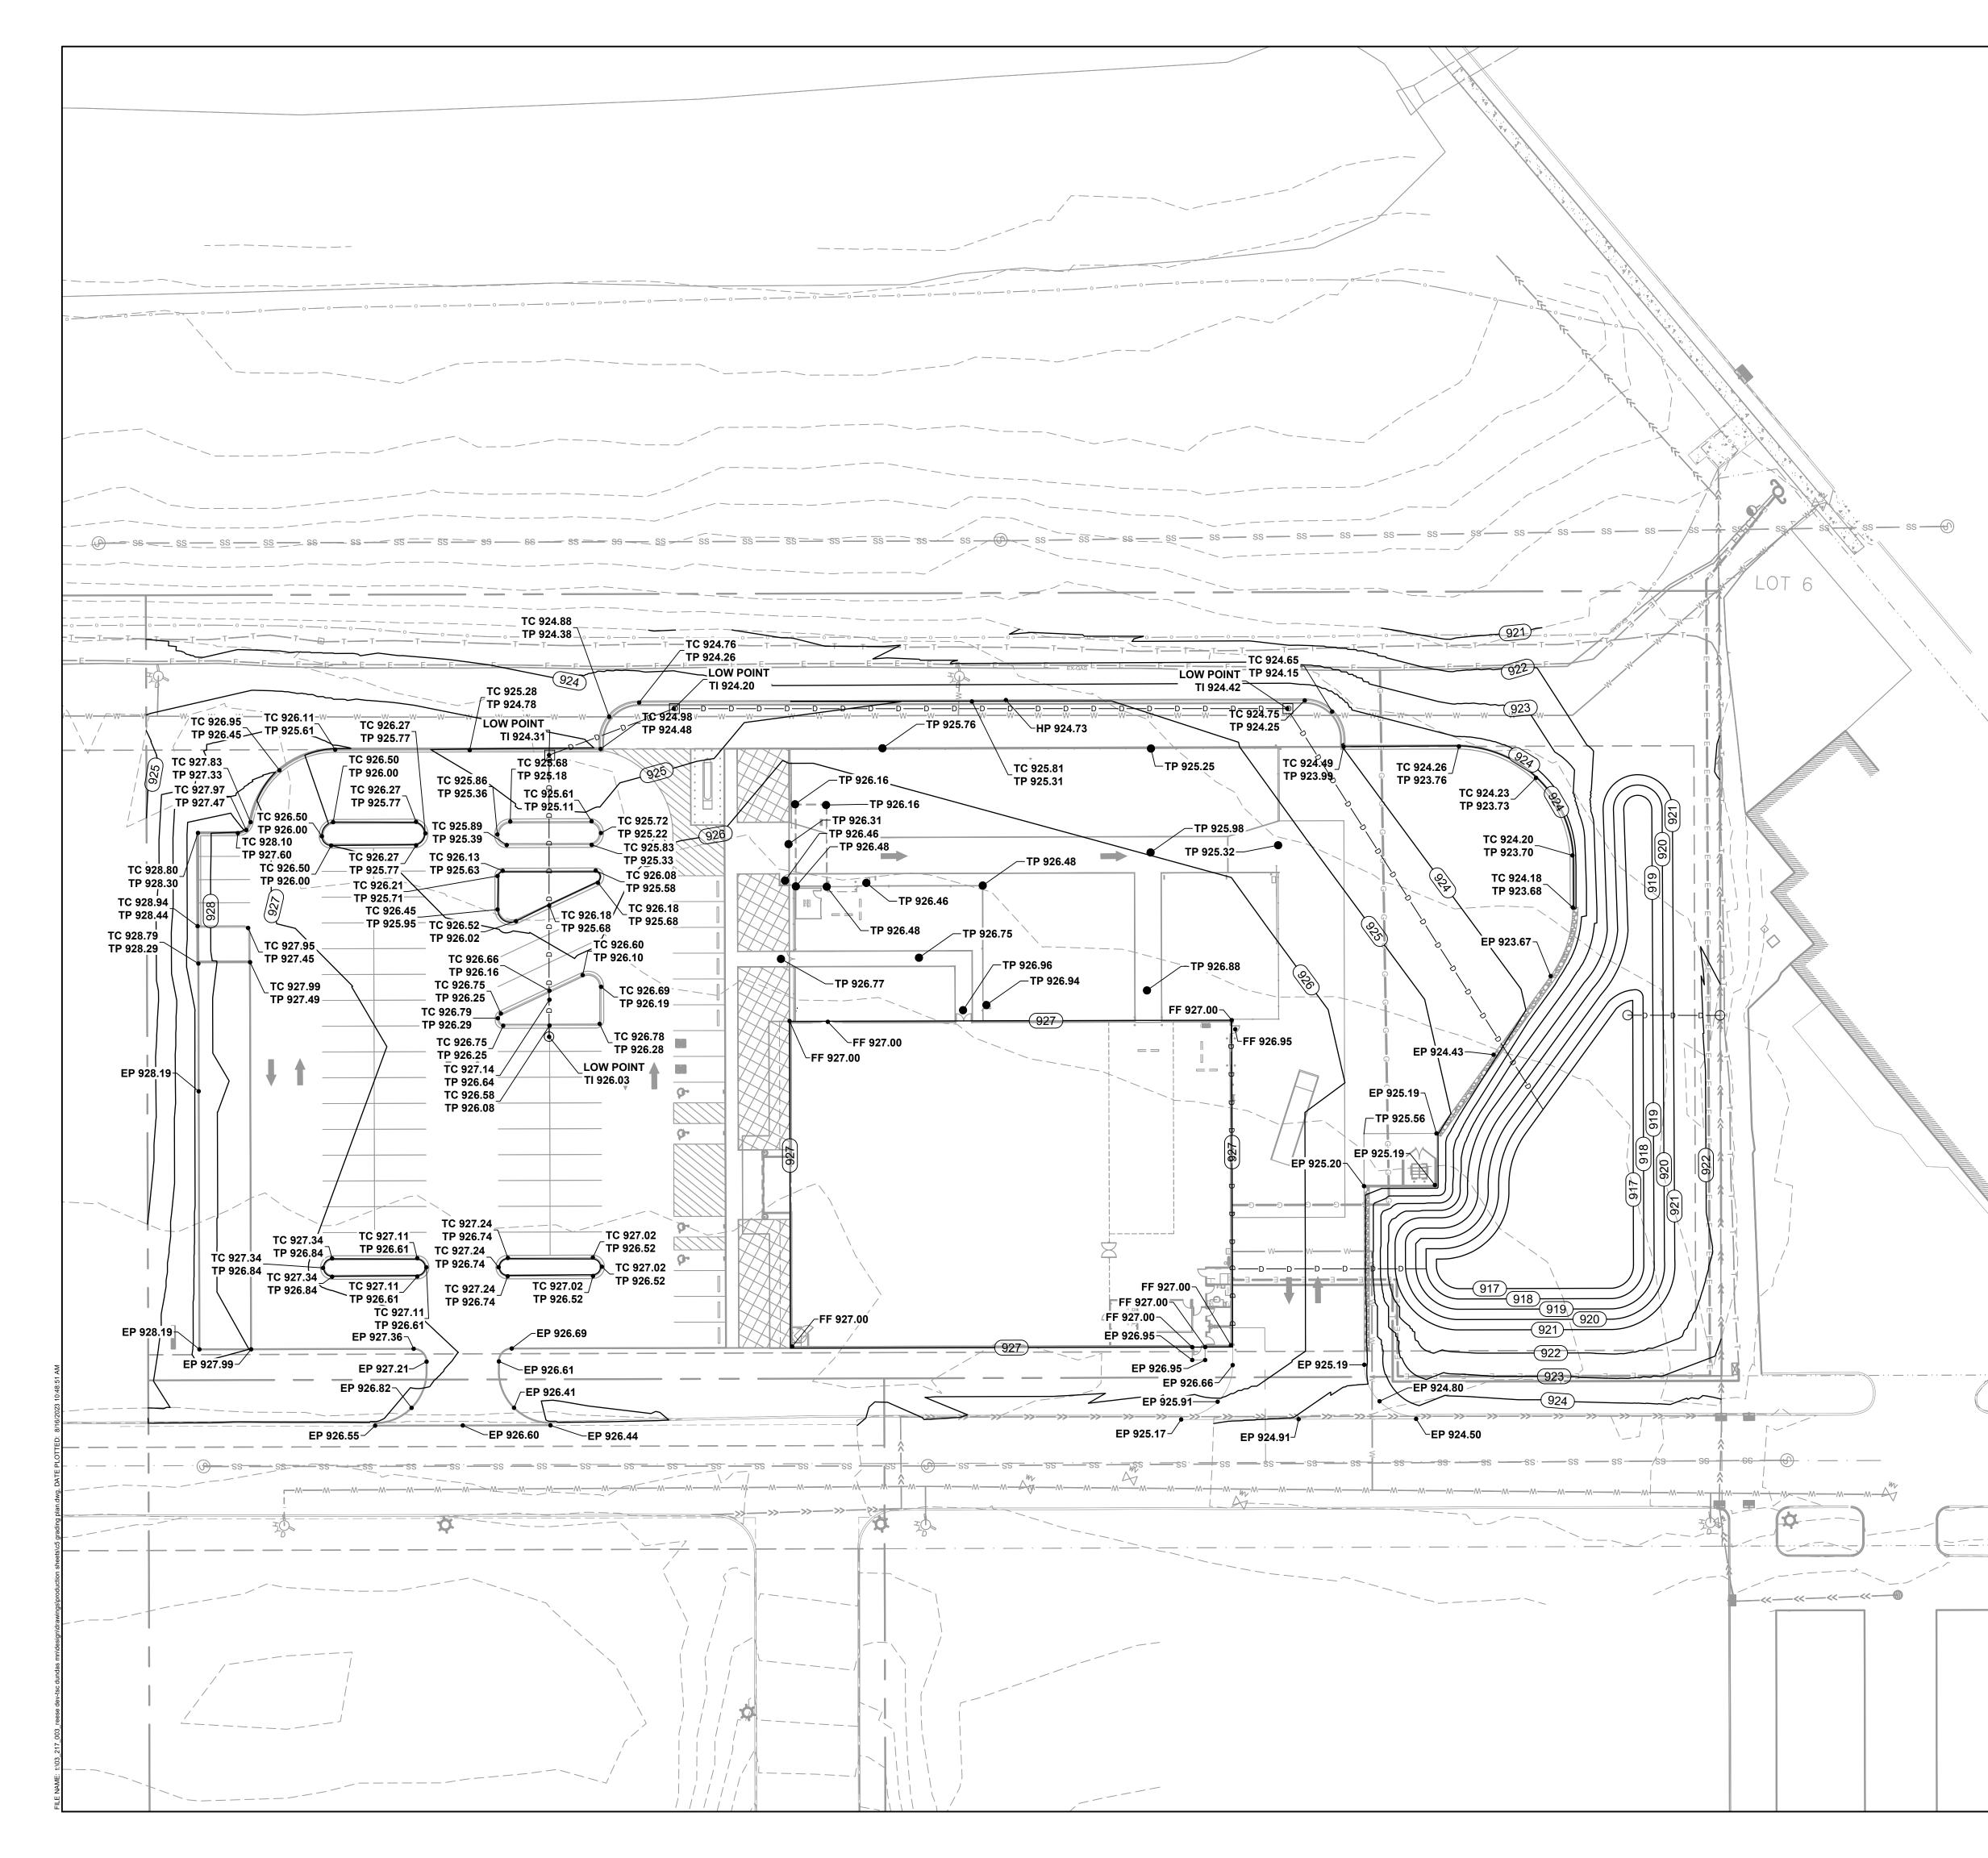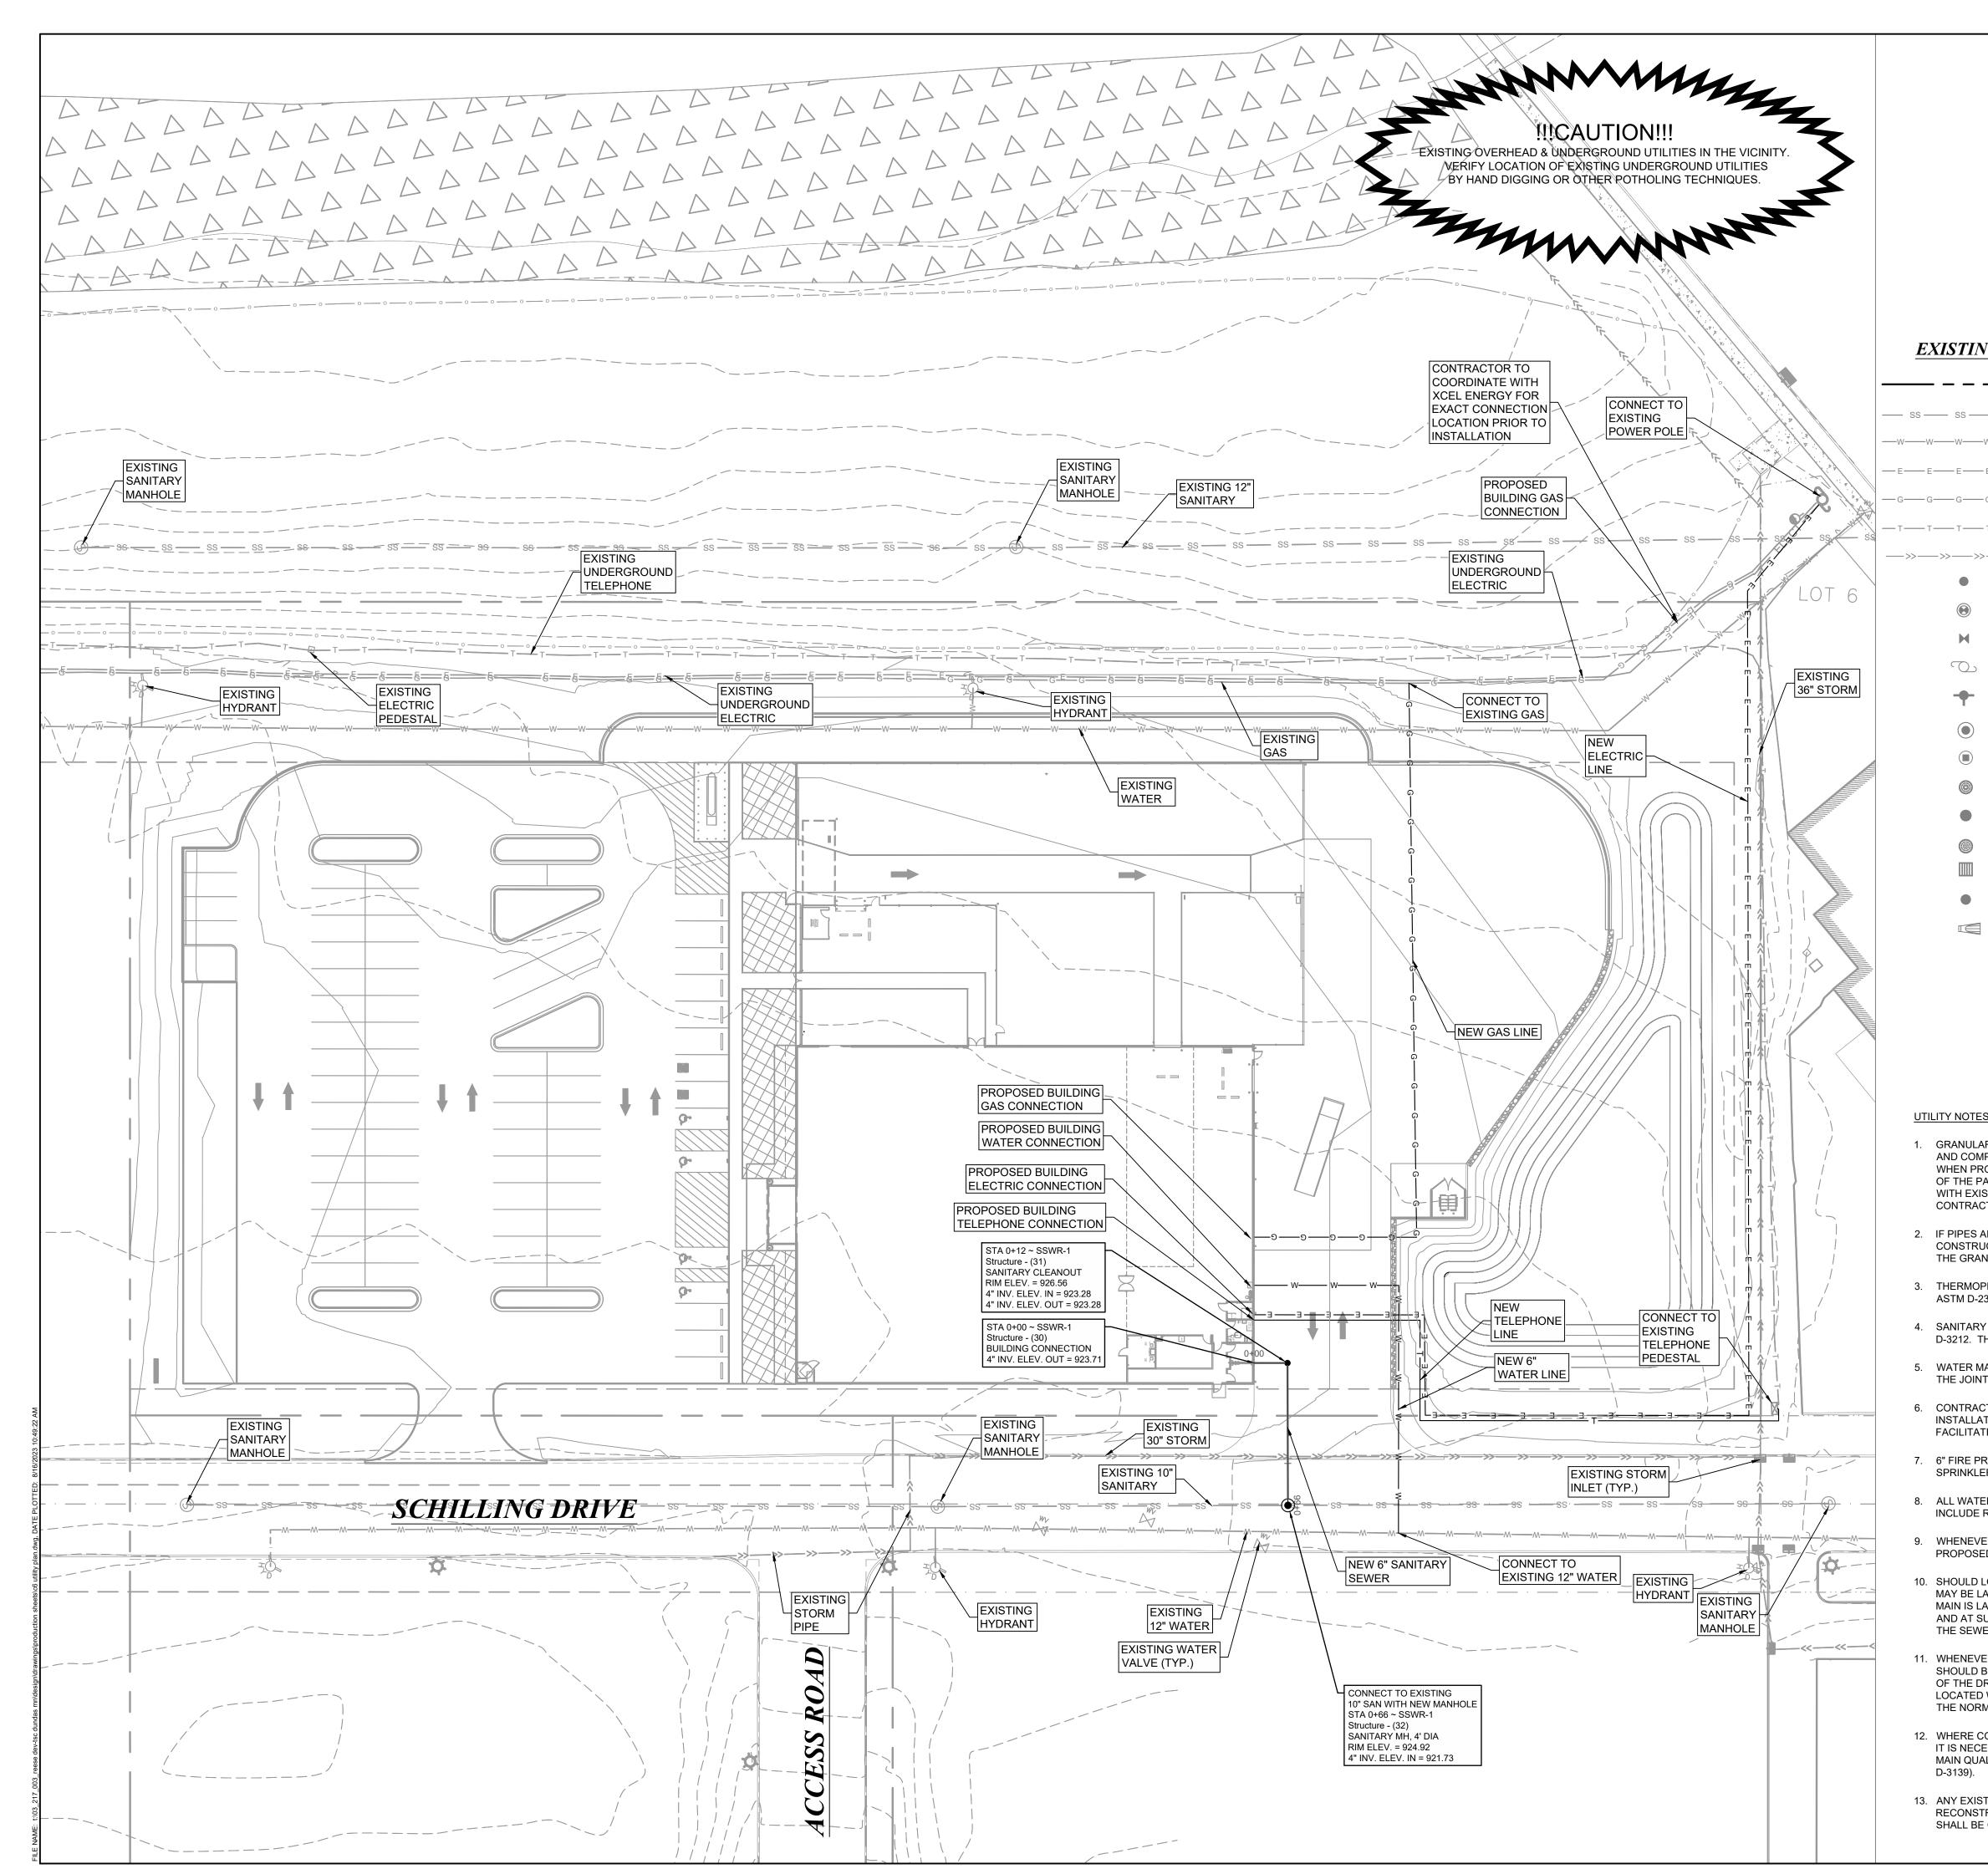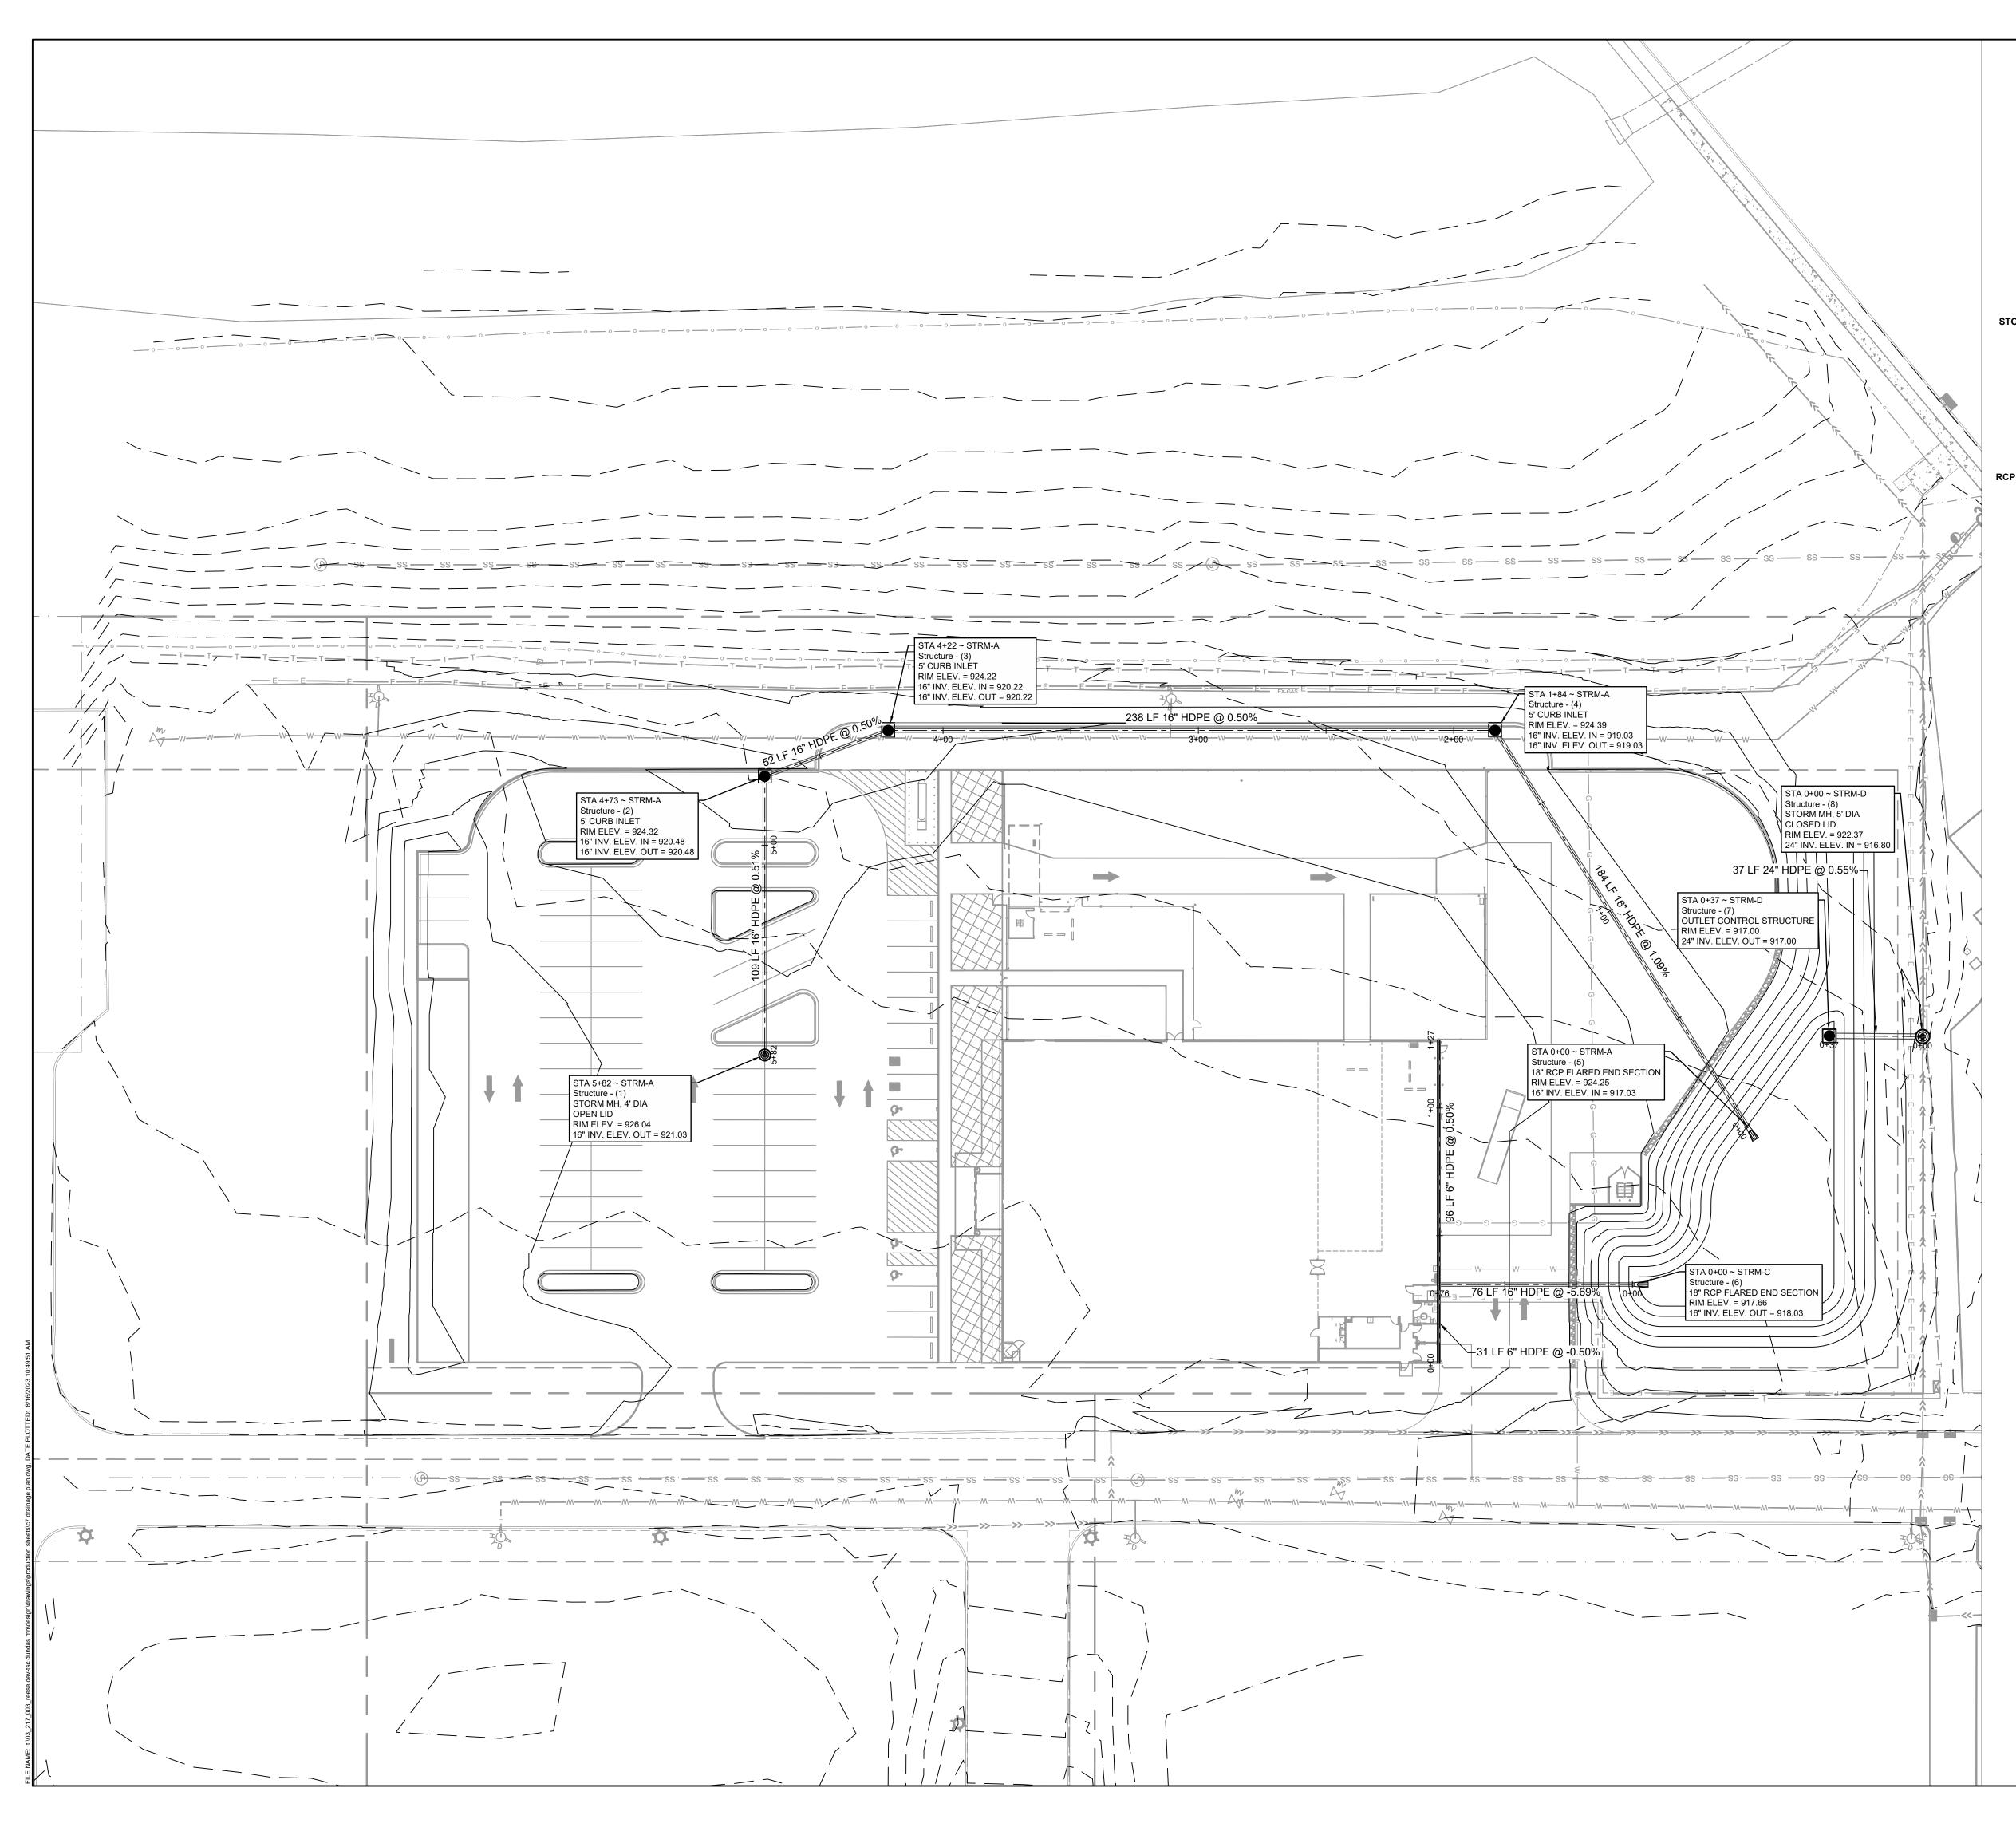


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	MATT GAUNTT	61596 8/16/23	
	TYPE OR PRINT NAME	PE # DATE	
	PROJEC	T NOTES:	
	BENCH	IMARKS:	
	BENCHMARK 1: HYDRANT - TNH ELEVATION: 924.27'		
	E: 483352.17 BENCHMARK 2: HYDRANT - TNH		
	HYDRANT - TNH ELEVATION: 928.93' N: 185882.21		
	N: 185882.21 E: 483286.41		
	BENCHMARK 3: HYDRANT - TNH ELEVATION: 929.07'		
	ELEVATION: 929.07' N: 185704.53 E: 783567.81		
	E: 783567.81 BENCHMARK 4: HYDRANT - TNH		
	HYDRANT - TNH ELEVATION: 927.66' N: 186124.24		
	REVISIONS /	ISSUANCES	
	No. DATE BY	DESCRIPTION	
	REESE I	DEV - TSC	
	PROJECT	ADDRESS	
		AS, MN	
	DRAINA	GE PLAN	
	PROJECT NUMBER:	03-217-003	
	DATE: 8/16/23	SCALE: 1"=30'	
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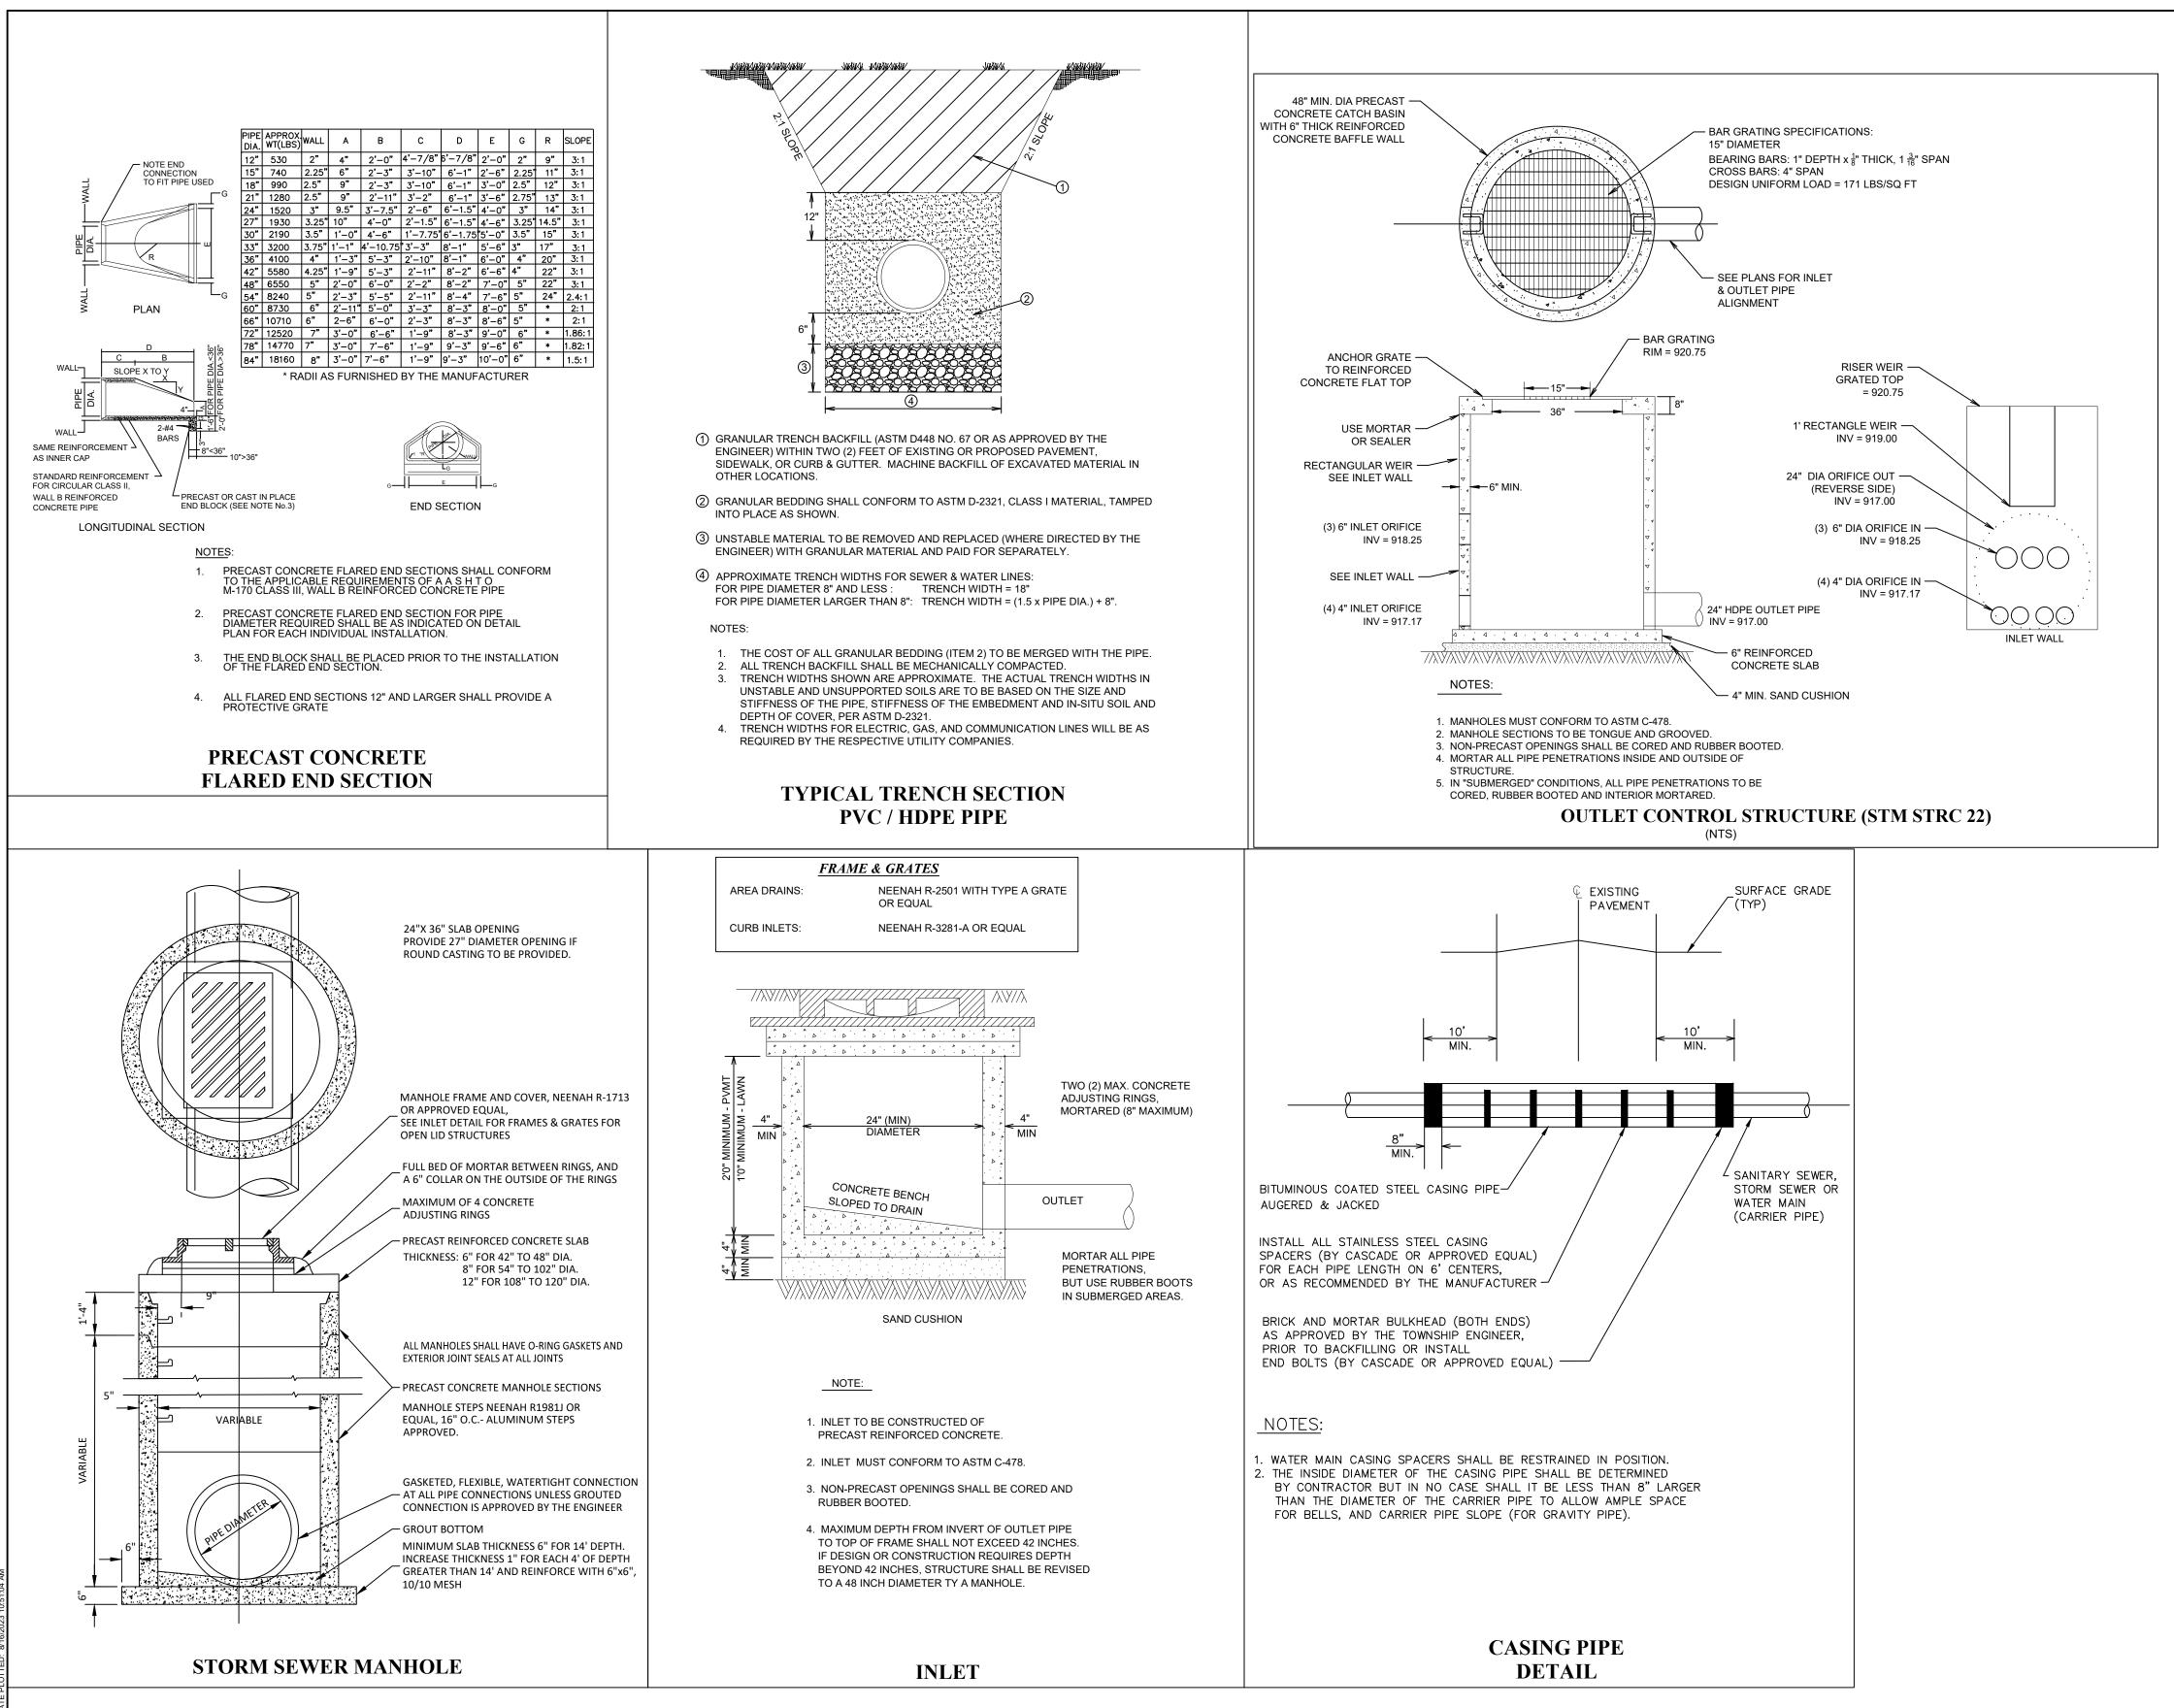
0 30'	60'
LEGEND	
RM SEWER LINE / DRAINAGE LINE (DOUBLE LINE)	
STORM MANHOLE, CLOSED LID	
STORM MANHOLE, OPEN LID	0
STORM CATCH BASIN, CLOSED LID	•
STORM CATCH BASIN, OPEN LID	0
STORM GRATE INLET/ CATCH BASIN STRUCTURE	m
STORM CLEANOUT	•
SFES (SAFETY FLARED END SECTION) W / GRATE	
CURB INLET	



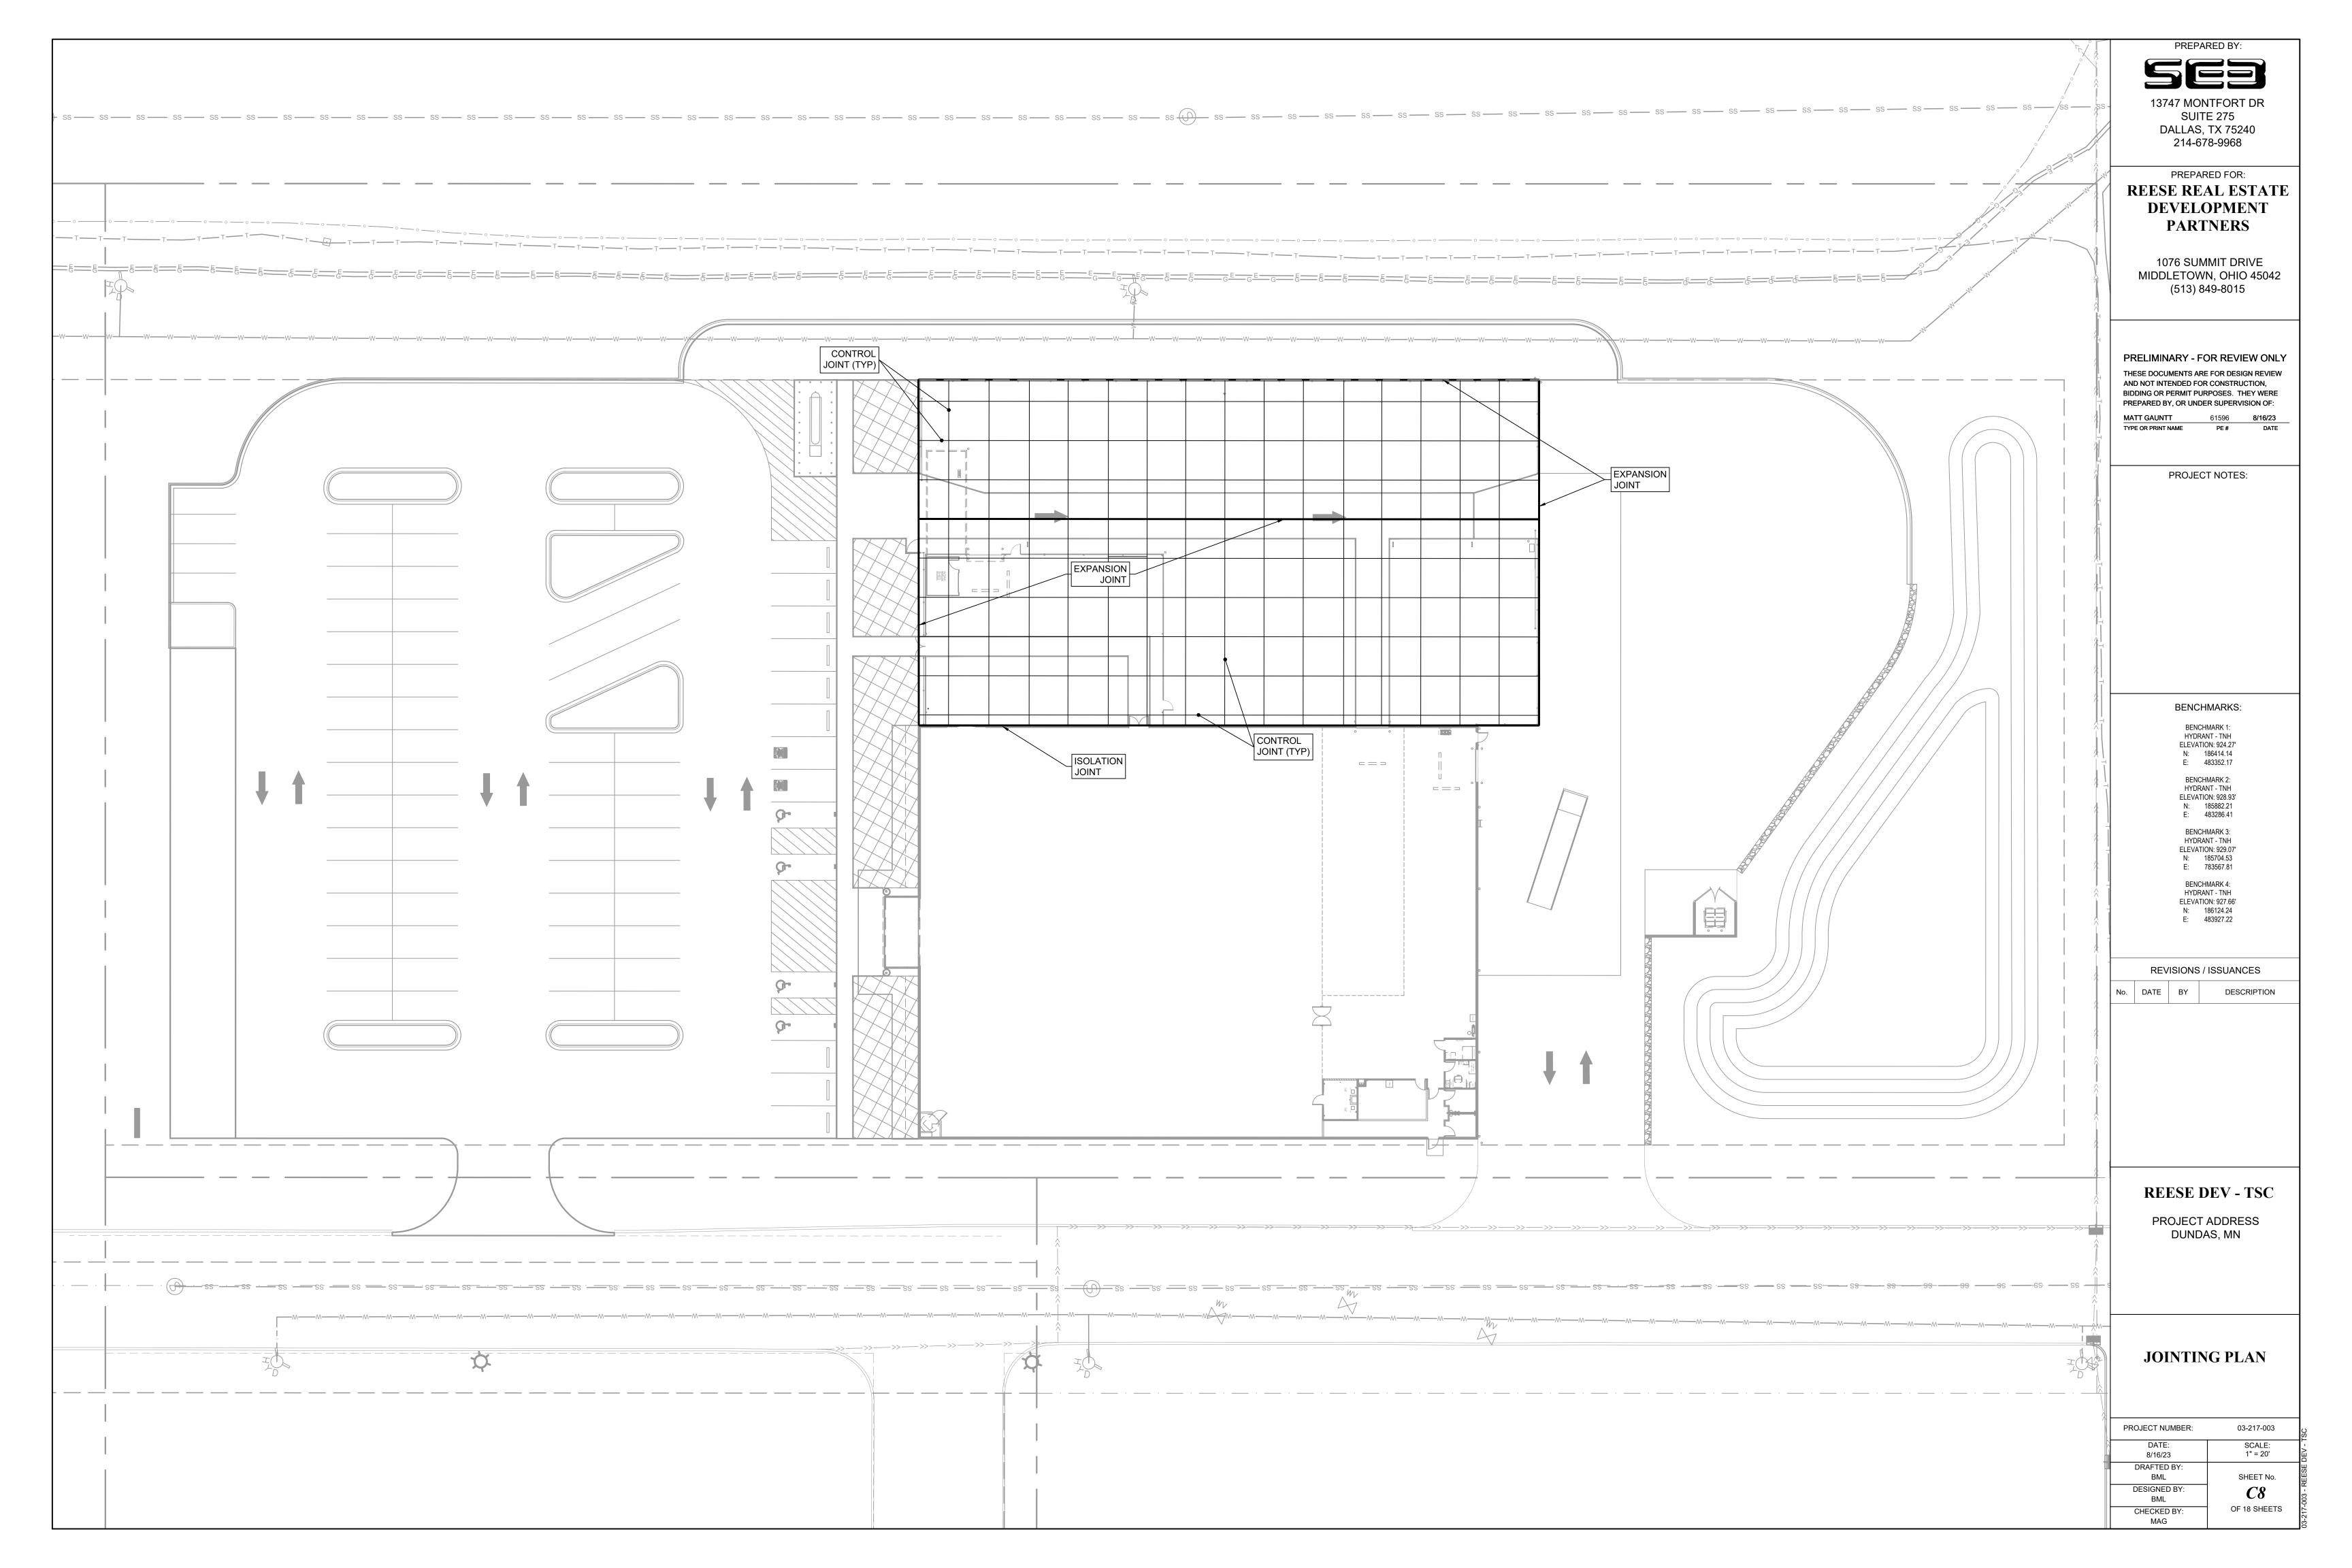


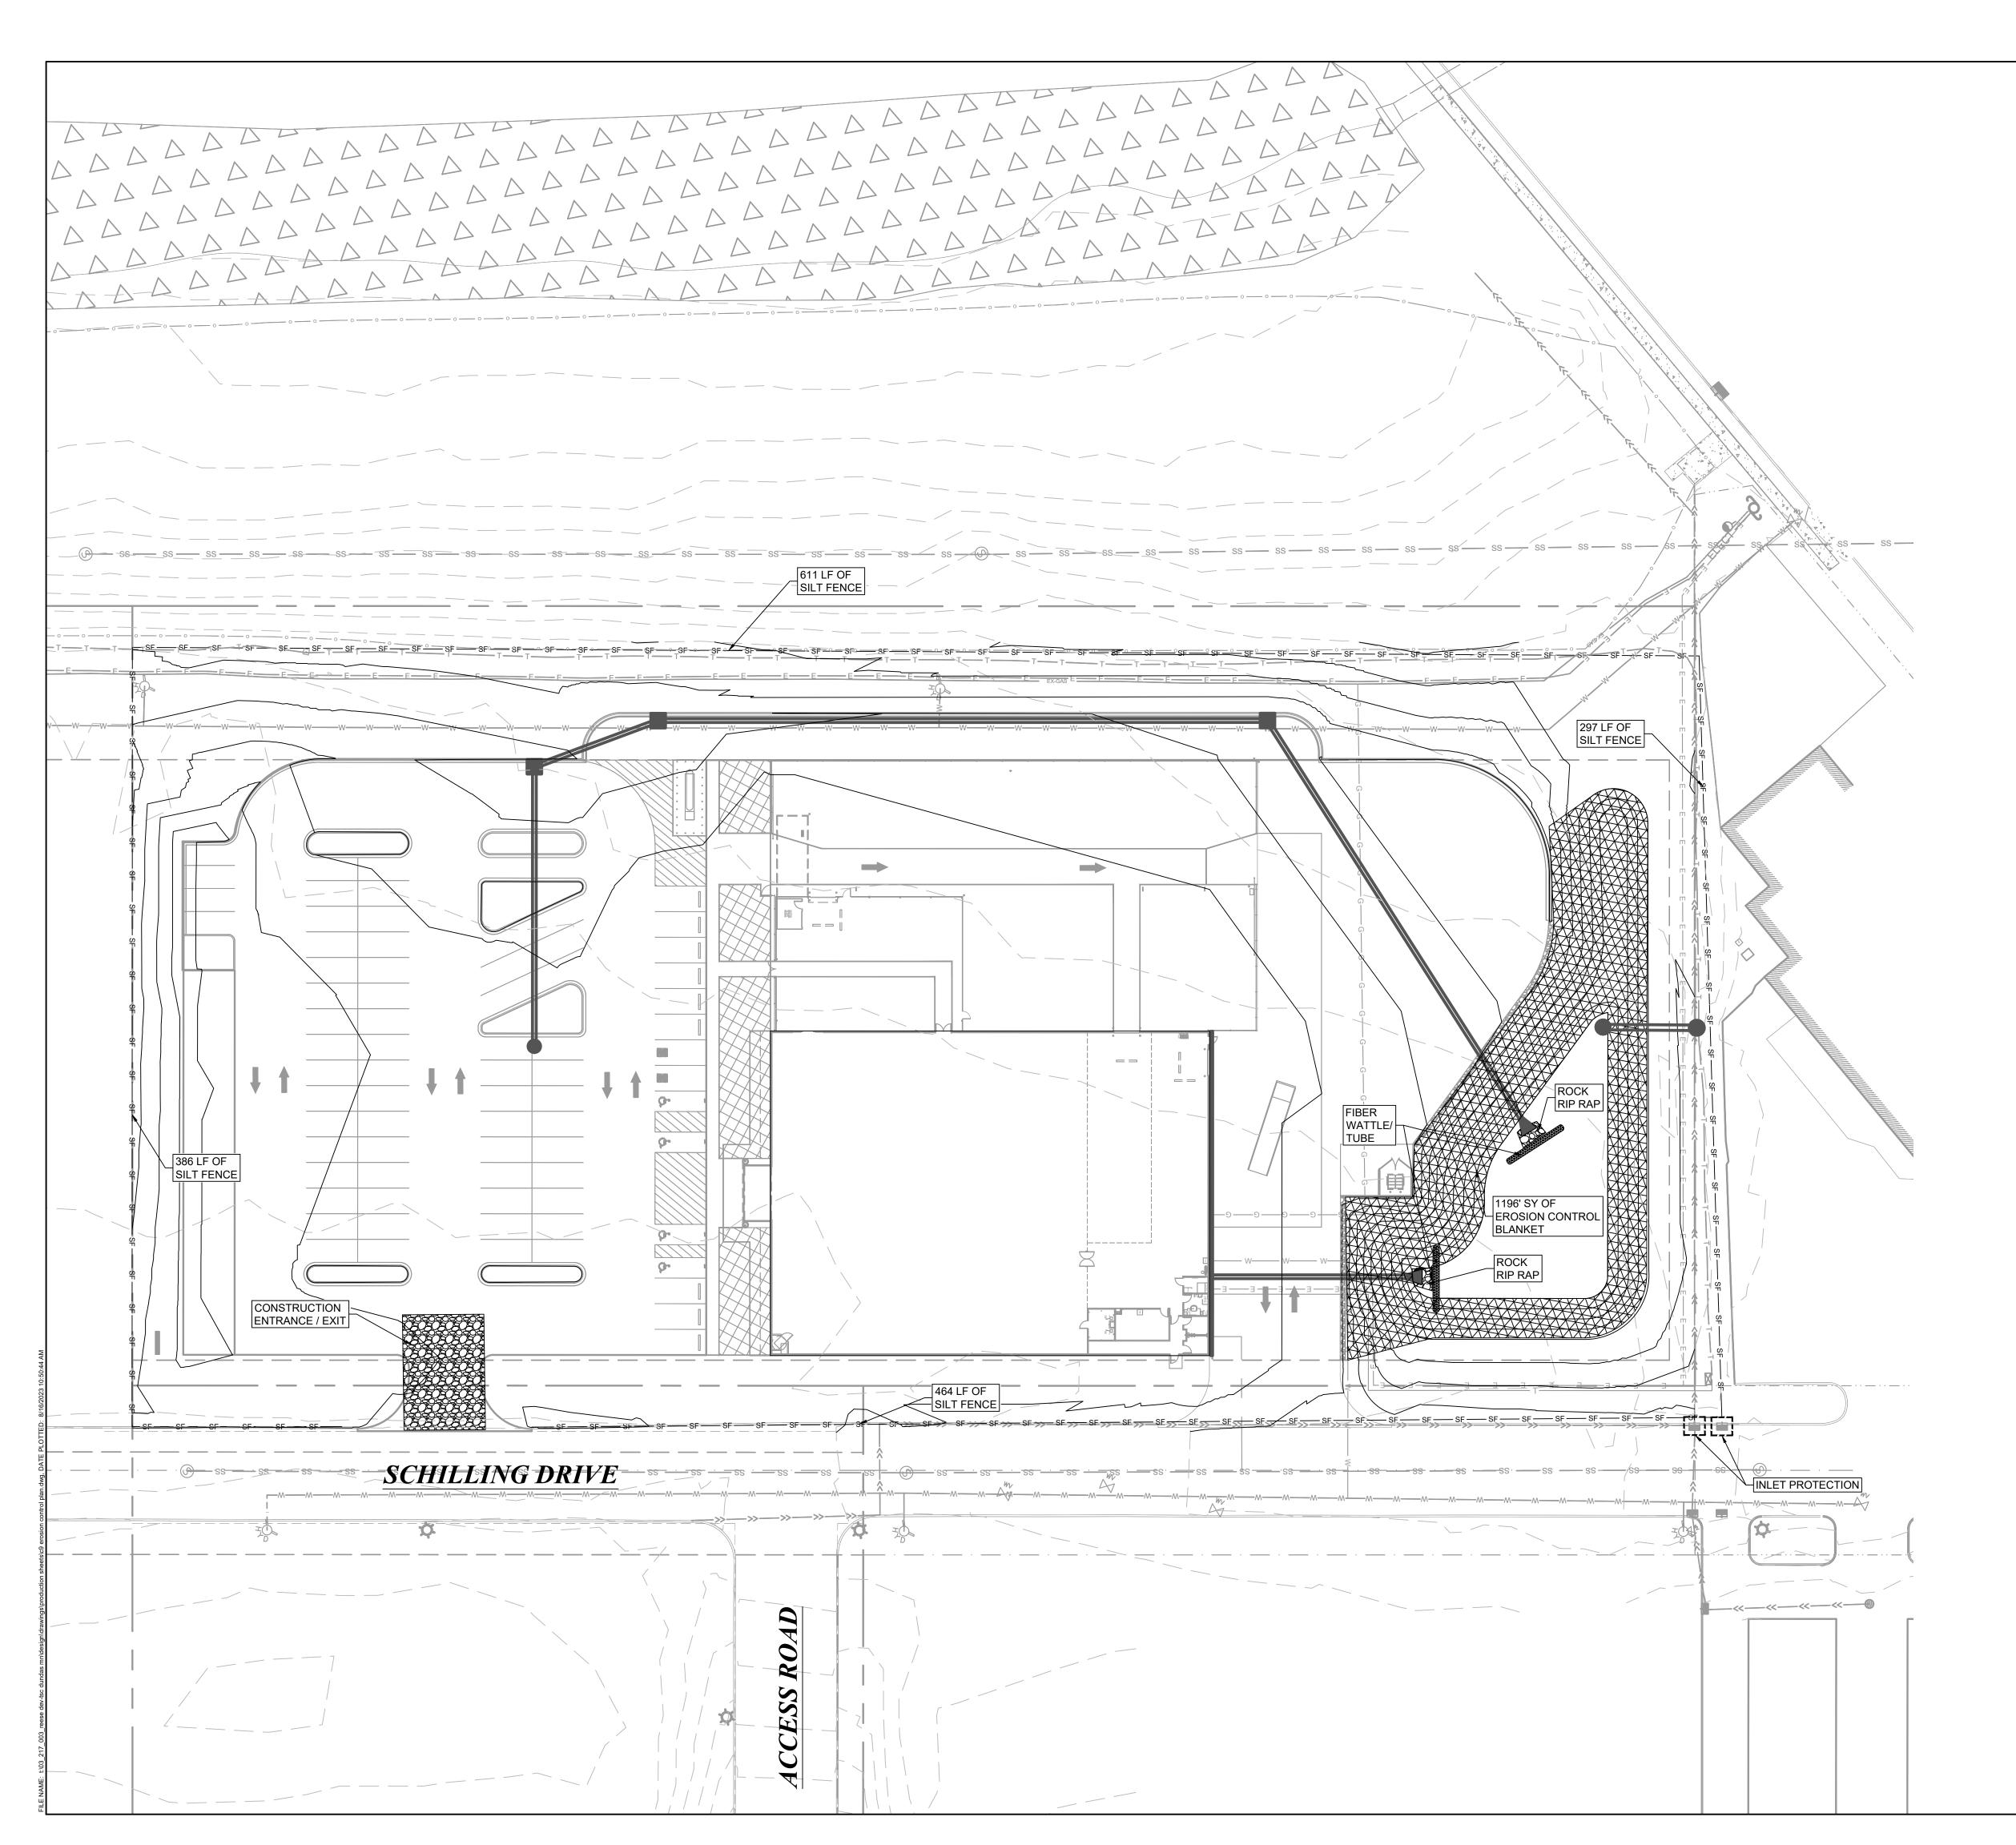
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		PROJEC	T NOTES:
1. 2. 3.	DTE: EROSION CONTROL BLANKET IS TO BE S75BN AS MANUFACTURED BY NORTH AMERICAN GREEN OR EQUIVALENT, EXCEPT WHERE NOTED OTHERWISE. INSTALL "FILTER BAG INLET PROTECTION" IN ALL OPEN LID DRAINAGE STRUCTURES, SEE DETAIL - NEXT SHEET. IT IS THE CONTRACTOR'S RESPONSIBILITY TO INDICATE ON THE PLANS THE LOCATION OF THE CONCRETE WASHOUT UPON INSTALLATION, SEE DETAIL - NEXT SHEET.		
<u>S</u>	ENERAL EROSION & EDIMENT CONTROL NOTES THE CONTRACTOR SHALL INSTALL SOIL EROSION AND SEDIMENT CONTROL MEASURES PRIOR TO ANY SOIL DISTURBANCE, OR IN THEIR PROPER SEQUENCE AND MAINTAIN THEM UNTIL PERMANENT STABILIZATION IS ESTABLISHED.		IMARKS:
2.	ADDITIONAL EROSION AND SEDIMENT CONTROL MEASURES MAY BE REQUIRED AS DEEMED NECESSARY BY THE OWNER OR THE CITY IN THE EVENT OF ANY UNFORESEEN PROBLEMS DURING CONSTRUCTION.	ELEVATI N: E:	NT - TNH ON: 924.27' 186414.14 483352.17 IMARK 2:
3.	THE CONTRACTOR SHALL LANDSCAPE OR VEGETATE DISTURBED AREAS THAT WILL BE LEFT EXPOSED MORE THAN 14 DAYS, AND NOT SUBJECT TO CONSTRUCTION TRAFFIC. IF THE SEASON PREVENTS THE ESTABLISHMENT OF A TEMPORARY COVER, STRAW MULCH SHALL BE APPLIED AT A RATE OF THREE (3) TONS PER ACRE OVERTOP EXPOSED AREAS.	HYDRA ELEVATI N: E:	NT - TNH ON: 928.93' 185882.21 483286.41 IMARK 3:
4.	THE CONTRACTOR SHALL CONTROL DUST WITH WATER OR OTHER METHODS APPROVED BY THE OWNER AND THE CITY.	HYDRA ELEVATI	NT - TNH ON: 929.07' 185704.53
5.	THE CONTRACTOR SHALL INSTALL SILT FENCE ALONG THE PERIMETER OF ALL SOIL STOCKPILES.	BENCH	783567.81 IMARK 4:
	THE STABILIZED CONSTRUCTION ENTRANCE SHALL BE MAINTAINED TO PREVENT TRACKING OF SEDIMENT ONTO PUBLIC STREETS. SEDIMENT TRACKED ON THE PUBLIC RIGHT-OF-WAY SHALL BE REMOVED IMMEDIATELY.	ELEVATI N:	NT - TNH ON: 927.66' 186124.24 483927.22
7.	SILT FENCE SHALL BE INSPECTED FOR DEPTH OF SEDIMENT, TEARS, TO SEE IF FABRIC IS SECURELY ATTACHED TO THE FENCE POSTS, AND TO SEE THAT THE FENCE POSTS ARE FIRMLY IN THE GROUND.		
8.	RIPRAP OUTLET PROTECTION SHALL BE INSPECTED AFTER HIGH FLOWS AND SHALL BE REPAIRED AS NEEDED.	No. DATE BY	DESCRIPTION
9.	FILTER FABRIC IS TO BE INSTALLED UNDER ALL RIPRAP.		
10.	ALL CONTROL MEASURES SHALL BE INSPECTED AT LEAST ONCE EACH WEEK AND FOLLOWING ANY STORM EVENT OF 0.5 INCHES OR GREATER.		
11.	DISTURBED AREAS AND AREAS USED FOR STORAGE OF MATERIALS THAT ARE EXPOSED TO PRECIPITATION SHALL BE INSPECTED FOR EVIDENCE OF, OR THE POTENTIAL FOR, POLLUTANTS ENTERING THE DRAINAGE SYSTEM.		
& i	<u>CHEDULE FOR EROSION</u> SEDIMENT CONTROL MEASURES		
1.	INSTALL STABILIZED ROCK CONSTRUCTION ENTRANCE AT THE LOCATION SHOWN ON THE PLAN OR AS DECIDED AT THE PRE-CONSTRUCTION MEETING.		
	INSTALL SILT FENCE AT THE LOCATIONS SHOWN ON THE PLAN. THE SILT FENCE SHALL REMAIN IN PLACE UNTIL THE SITE IS STABILIZED WITH A UNIFORM 70% PERENNIAL VEGETATIVE COVER. BEGIN EARTHWORK AND GRADING OPERATIONS IF NECESSARY. STOCKPILES		DEV - TSC
	AND DISTURBED PORTIONS OF THE SITE WHERE CONSTRUCTION ACTIVITY TEMPORARILY CEASES FOR AT LEAST 14 DAYS WILL BE STABILIZED WITH TEMPORARY SEED AND MULCH NO LATER THAN 7 DAYS FROM THE LAST CONSTRUCTION ACTIVITY IN THAT AREA FOR DISTURBED AREAS AND NO LATER THAN 3 DAYS FOR TEMPORARY STOCKPILES.		ADDRESS AS, MN
т .	INSTALL UNDERGROUND UTILITIES. INSTALL INLET AND OUTLET PROTECTION AROUND ALL STORM SEWER STRUCTURES AS SHOWN ON THE PLAN. INLET PROTECTION SHALL REMAIN IN PLACE UNTIL THE SITE IS STABILIZED WITH PAVING AND A UNIFORM 70% PERENNIAL VEGETATIVE COVER ON ALL AREAS TRIBUTARY TO THE INLETS.		
	PAVE PARKING AREA AND ACCESS DRIVES.		CONTROL
	COMPLETE FINAL GRADING AND INSTALL REMAINING PERMANENT SEEDING, PLANTING, & EROSION CONTROL BLANKET. ONCE THE SITE IS STABILIZED WITH PAVING AND A UNIFORM 70% PERENNIAL VEGETATIVE COVER IS ACHIEVED ON ALL DISTURBED AREAS, FLUSH ALL STORM	PL.	£111
	SEWERS AND REMOVE REMAINING EROSION CONTROL DEVICES. CLEAN OUT SEDIMENT FROM PIPE OUTLET AREAS IF NECESSARY.	PROJECT NUMBER:	03-217-003
3.	FILE AN NPDES NOTICE OF TERMINATION (NOT).	DATE: 8/16/23	SCALE: 1"=30'
		DRAFTED BY: BML DESIGNED BY:	SHEET No.
		BML CHECKED BY: MAG	C9 OF 18 SHEETS




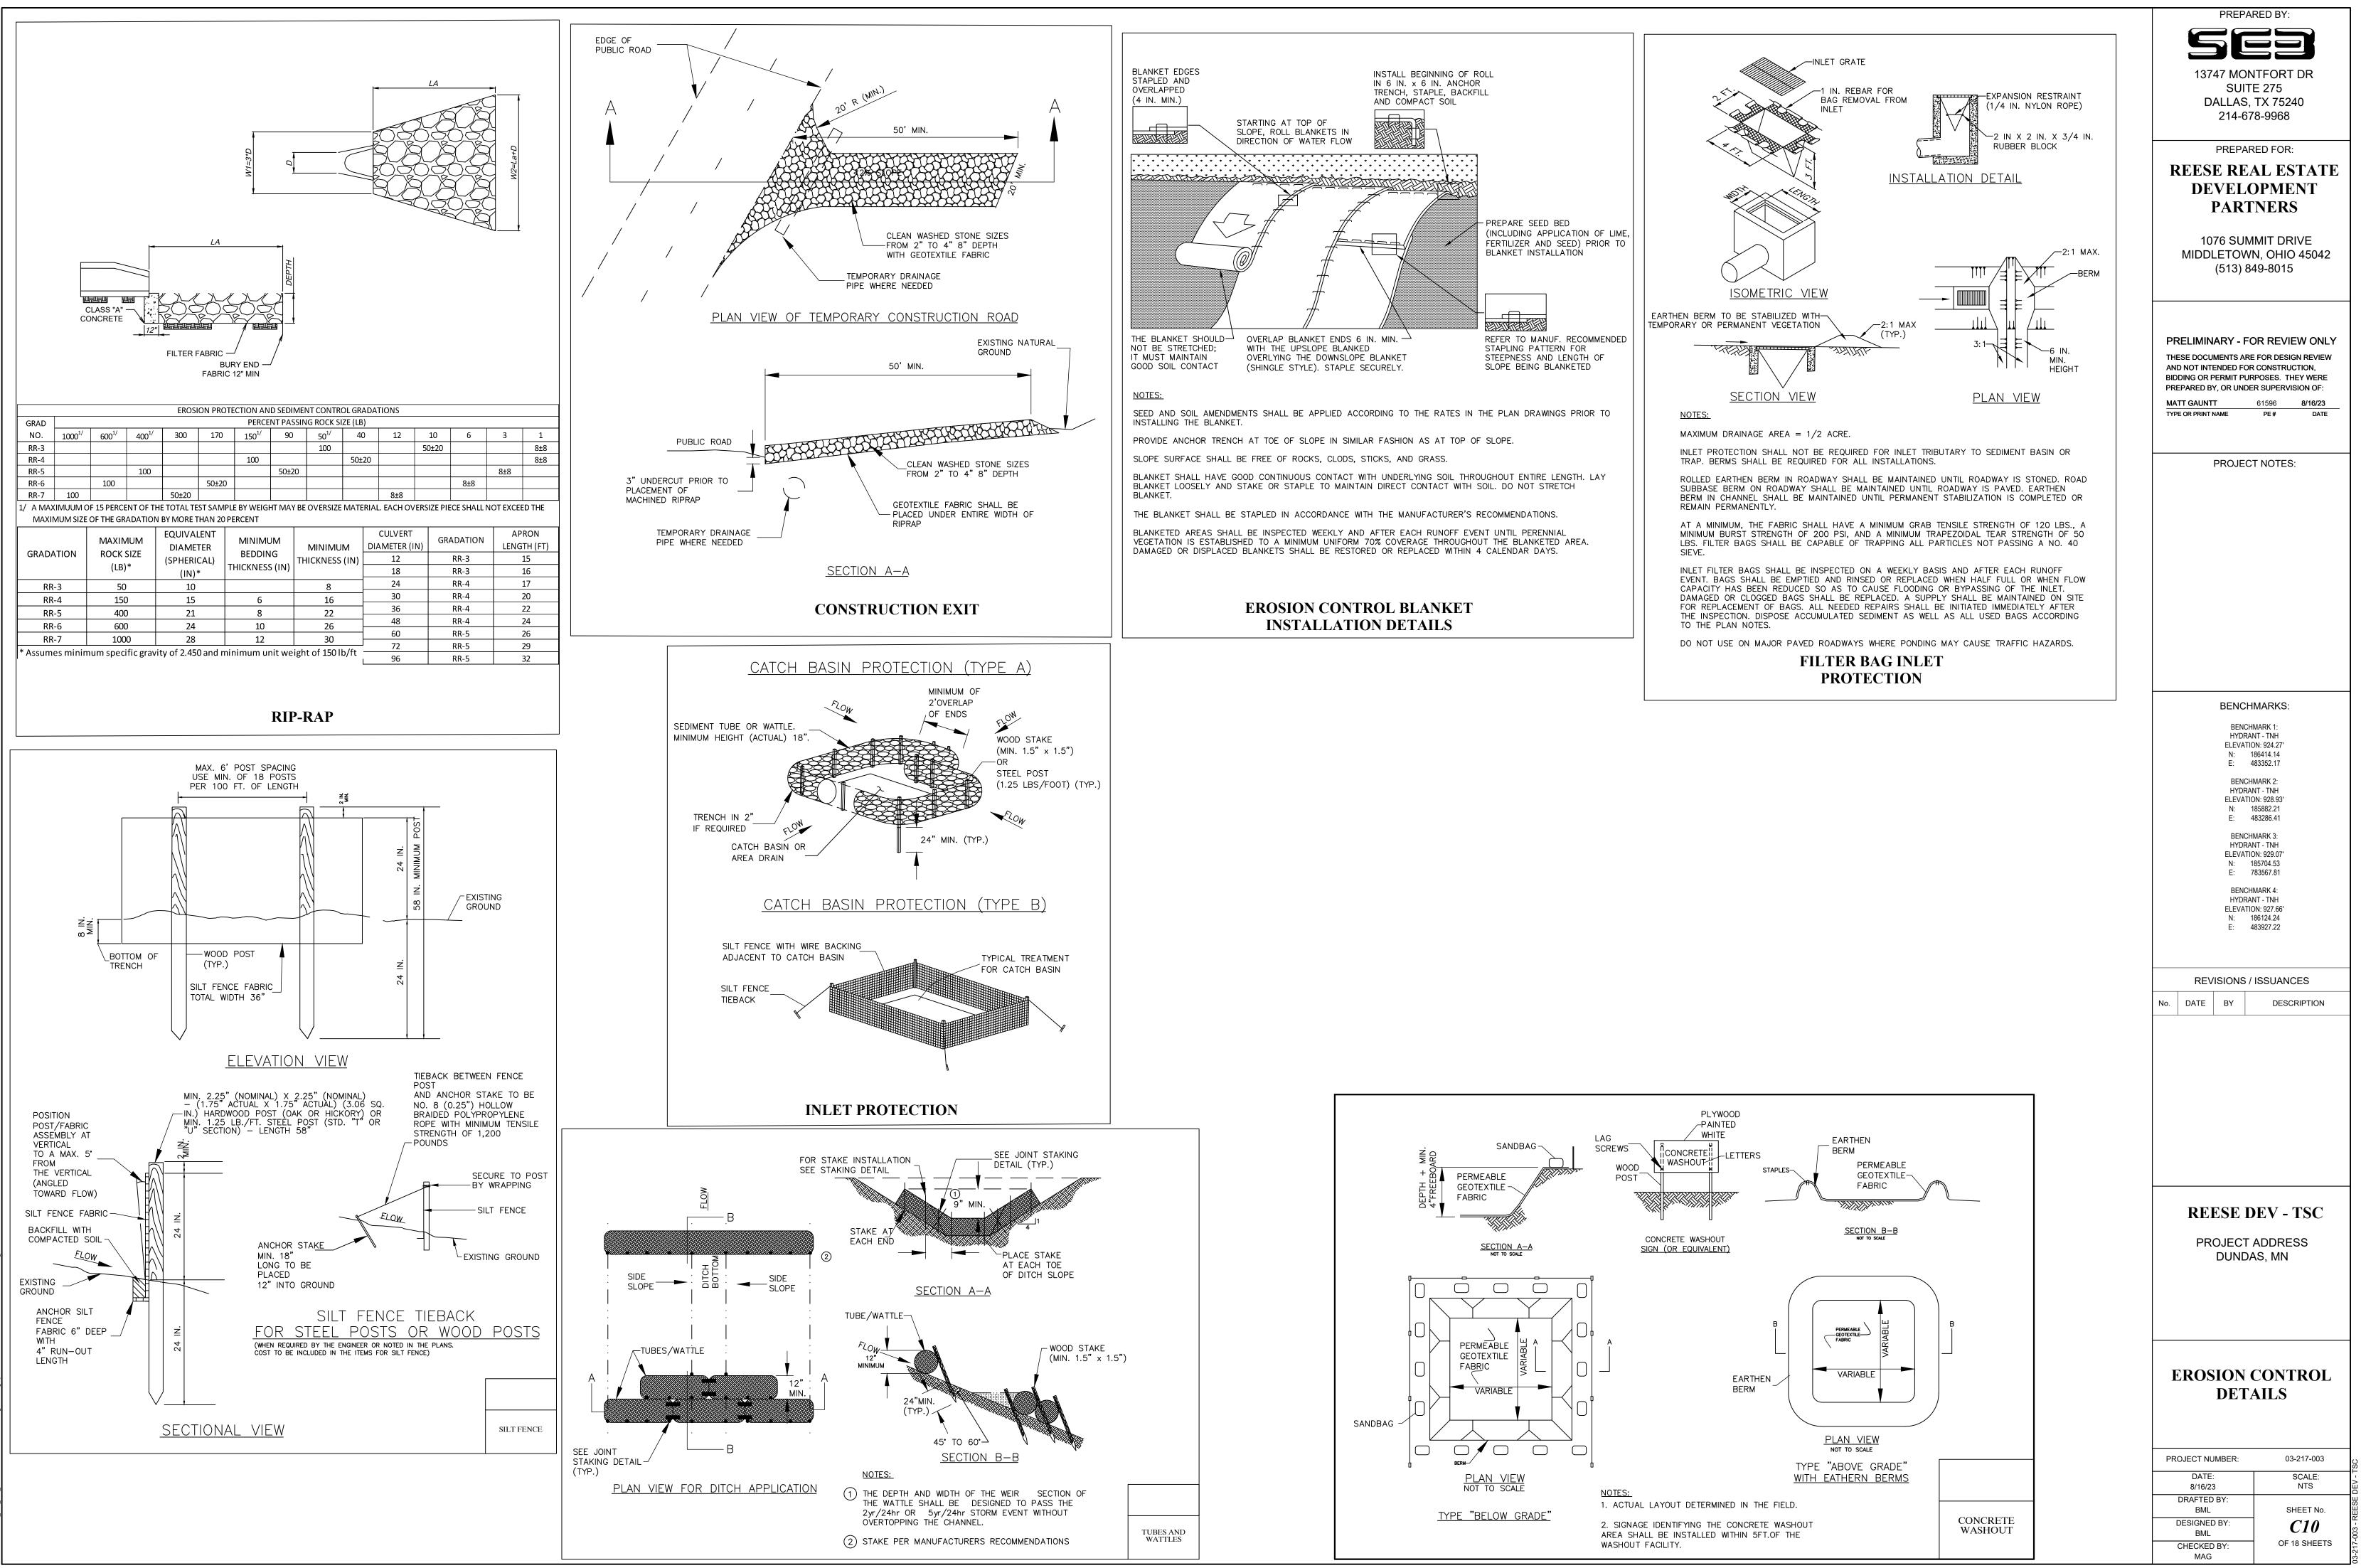


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	N, OHIO 45042 49-8015
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AND NOT INTENDED FOR BIDDING OR PERMIT PUR PREPARED BY, OR UNDE	POSES. THEY WERE
MATT GAUNTT	61596 8/16/23
TYPE OR PRINT NAME	PE # DATE
PROJEC	T NOTES:
BENCH	MARKS:
HYDRA	MARK 1: NT - TNH
N: 1	DN: 924.27' 86414.14 !83352.17
	MARK 2:
ELEVATIO	NT - TNH DN: 928.93' 85882.21
	183286.41
HYDRA	MARK 3: NT - TNH
N: 1	DN: 929.07' 85704.53 '83567.81
	MARK 4:
ELEVATIO	NT - TNH DN: 927.66' 86124.24
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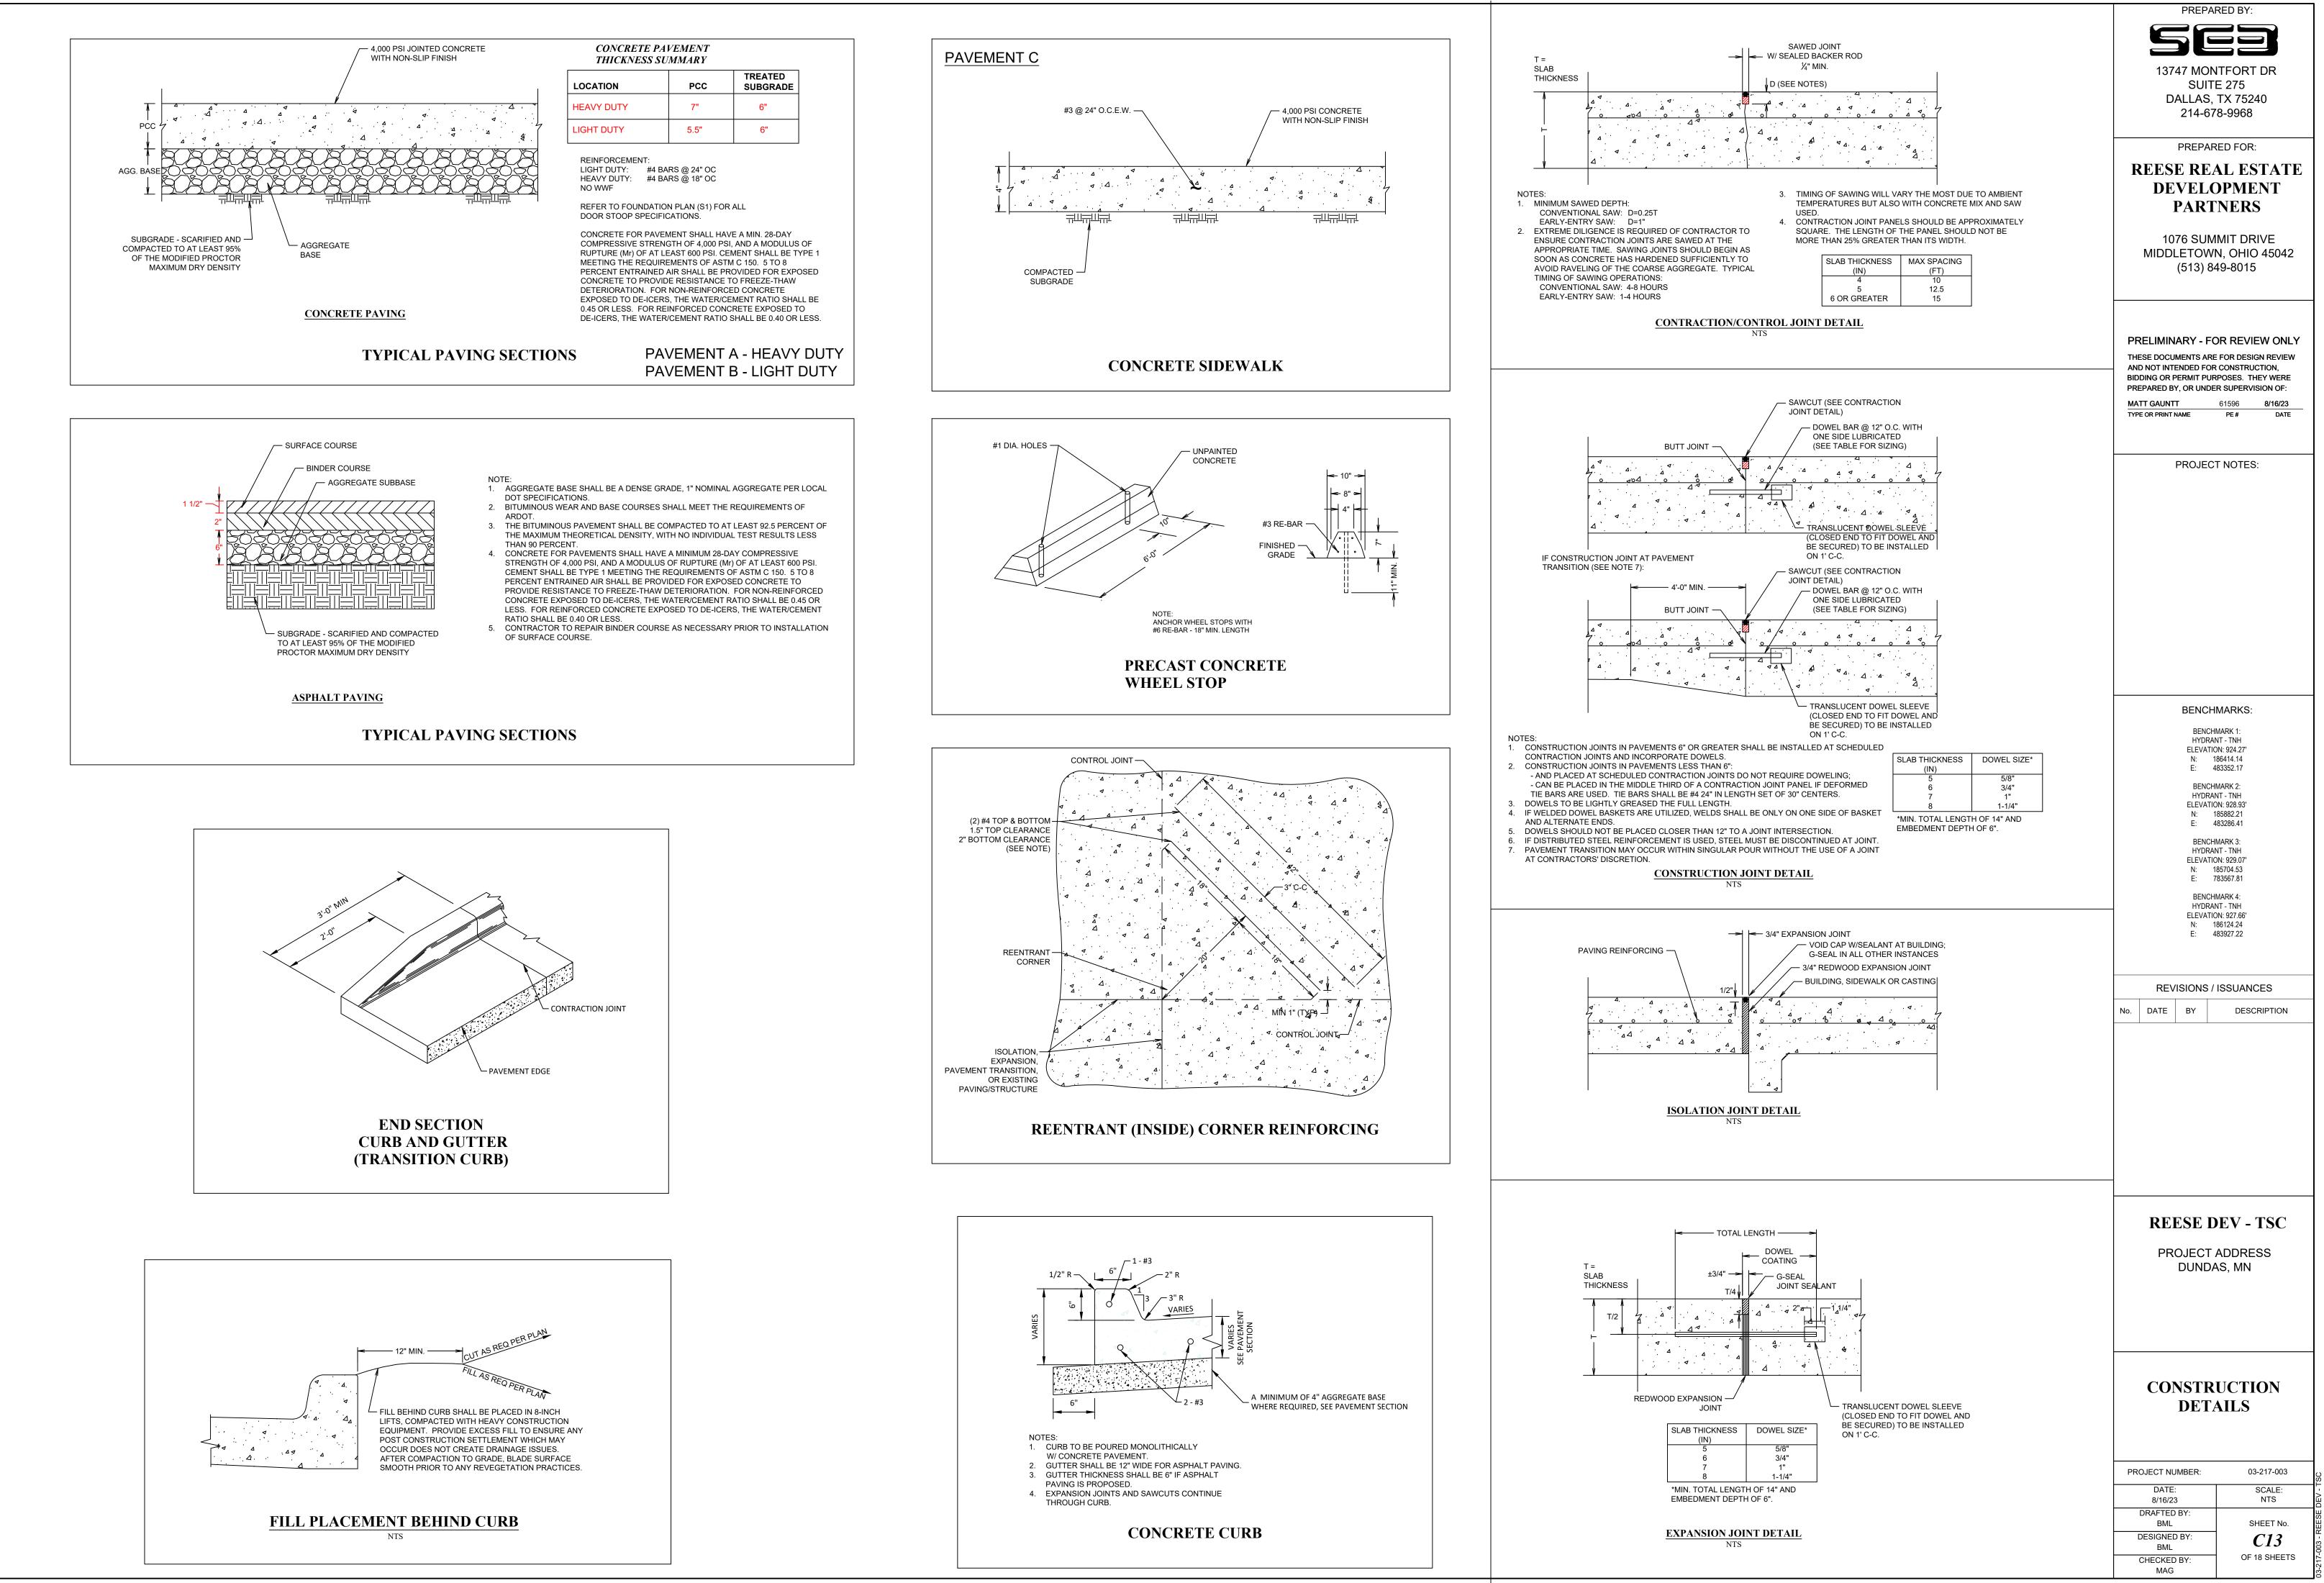


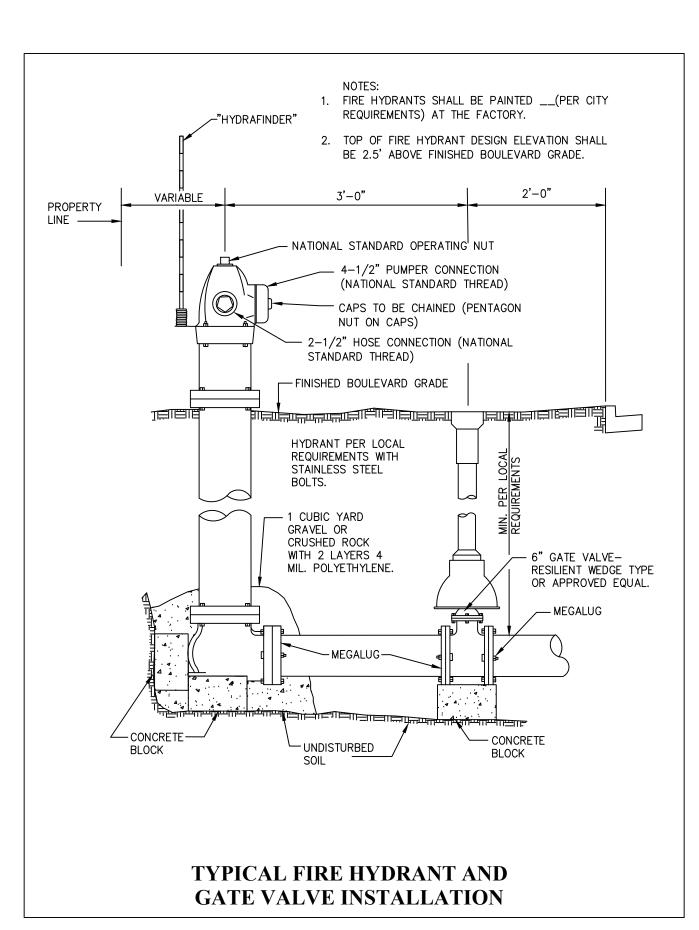

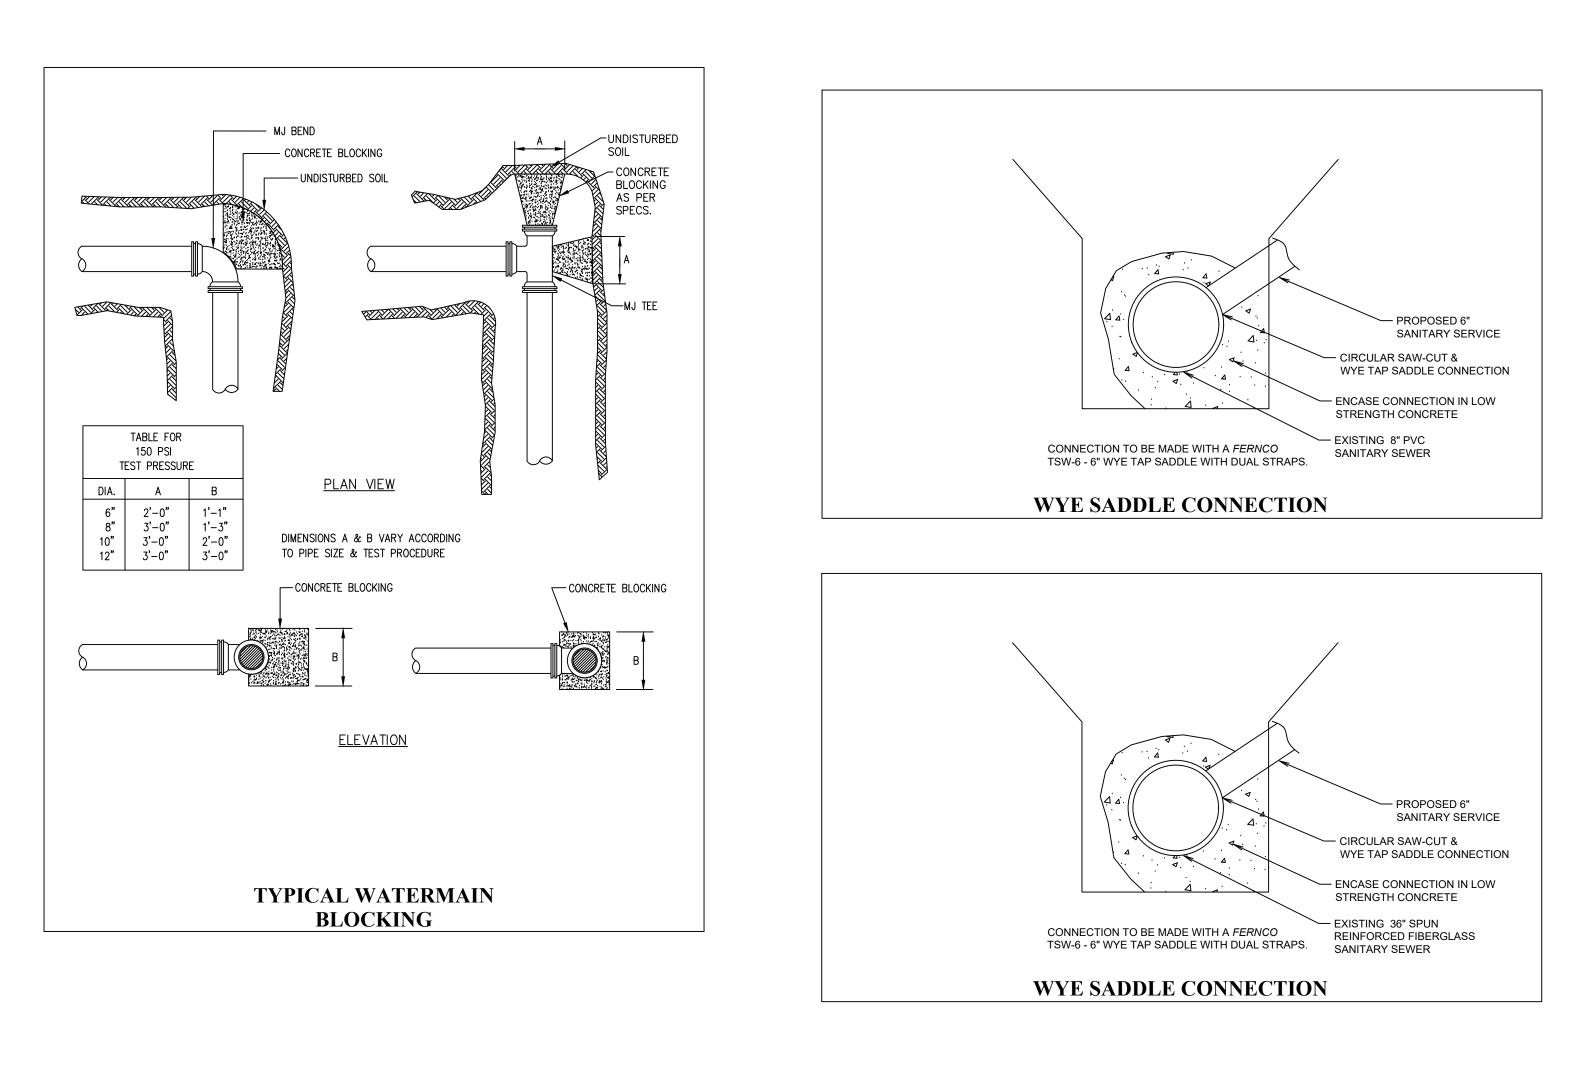


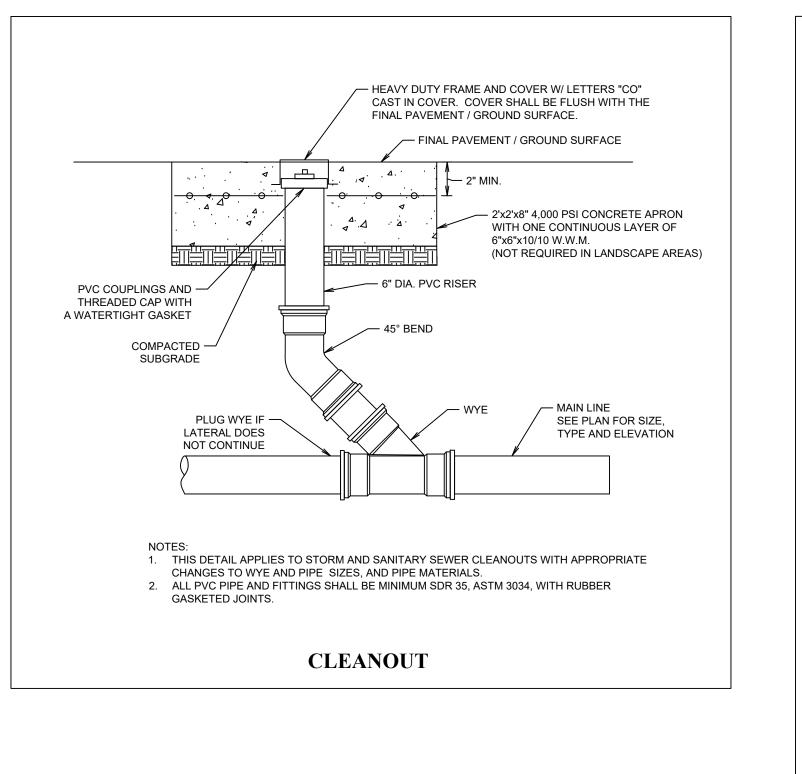


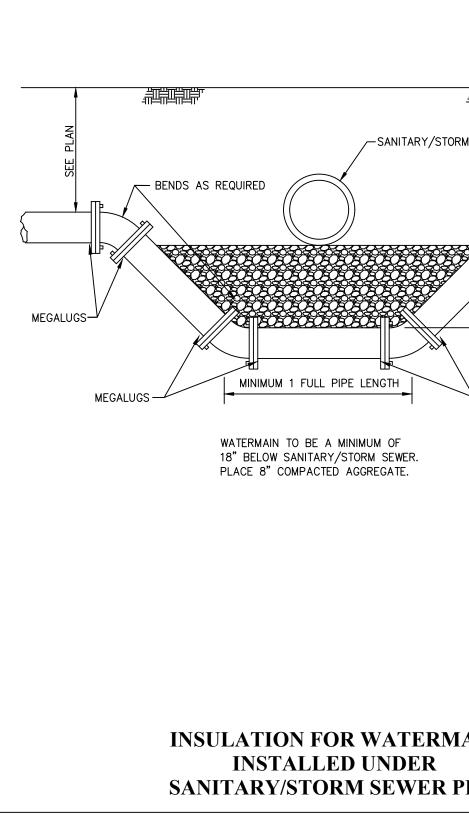
	PREPARED BY:
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	JEJ
	13747 MONTFORT DR SUITE 275
	DALLAS, TX 75240
	214-678-9968
	PREPARED FOR:
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	DEVELOPMENT
	PARTNERS
	1076 SUMMIT DRIVE
	MIDDLETOWN, OHIO 45042
	(513) 849-8015
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	MATT GAUNTT 61596 8/16/23 TYPE OR PRINT NAME PE # DATE
	TTPE OR PRINT NAME PE # DATE
	PROJECT NOTES:
	BENCHMARKS:
	BENCHMARK 1: HYDRANT - TNH
	ELEVATION: 924.27' N: 186414.14 E: 483352.17
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SEE UTILITY PLAN FOR ELEVATION MEGALUGS F WER. .TE.	PROJECT ADDRESS DUNDAS, MN CONSTRUCTION DETAILS PROJECT NUMBER: 03-217-003 DATE: SCALE: 8/16/23 NTS DRAFTED BY: SHEET NO.
SEE UTILITY PLAN FOR ELEVATION MEGALUGS F. WER. TE.	PROJECT ADDRESS DUNDAS, MN CONSTRUCTION DETAILS PROJECT NUMBER: 03-217-003 DATE: SCALE: 8/16/23 NTS DRAFTED BY:






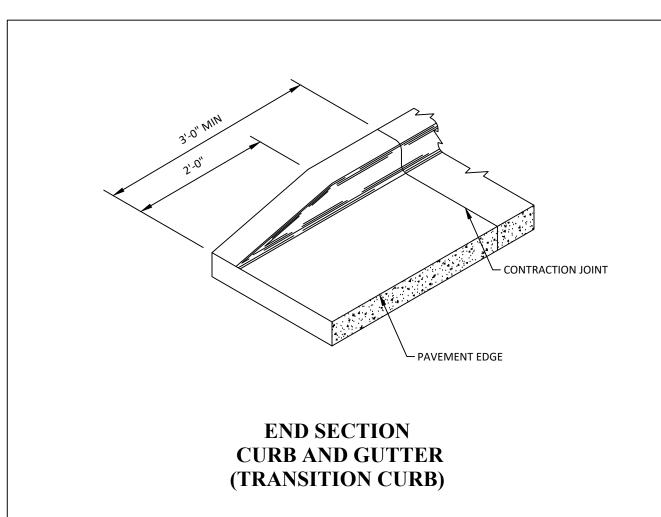

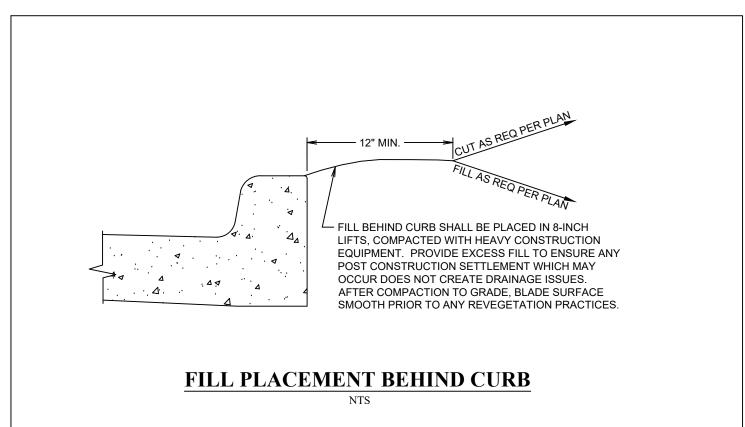


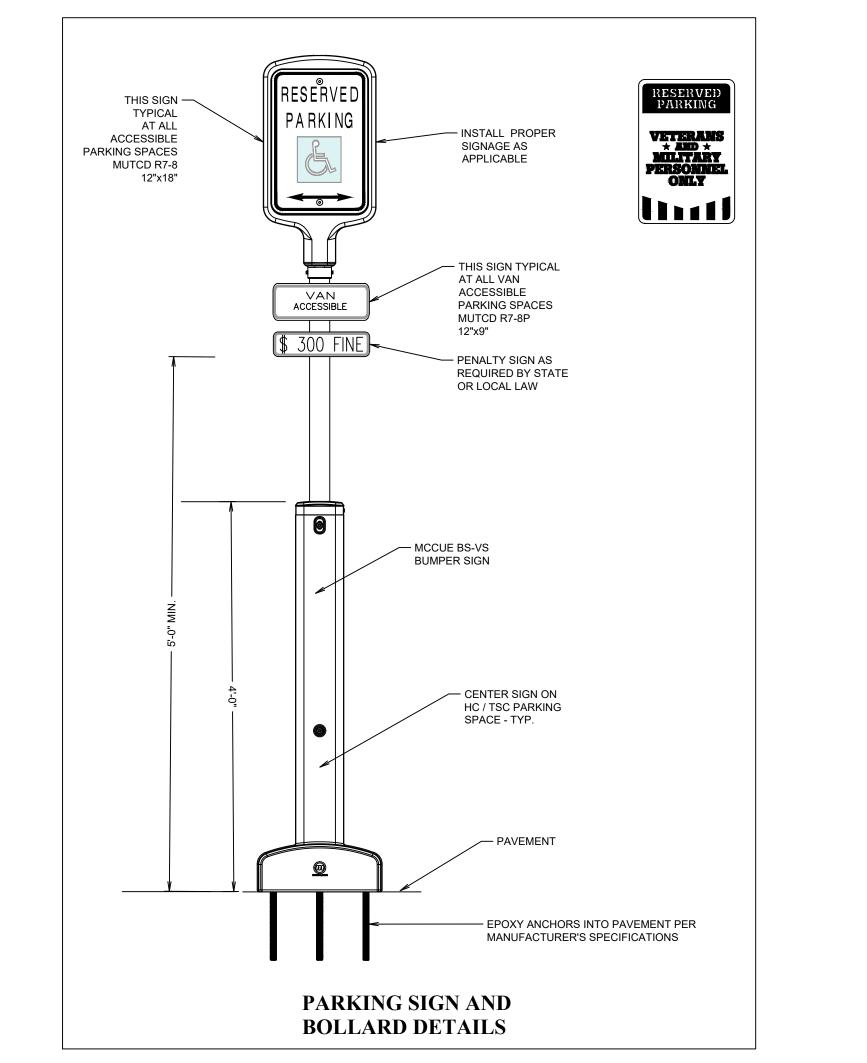

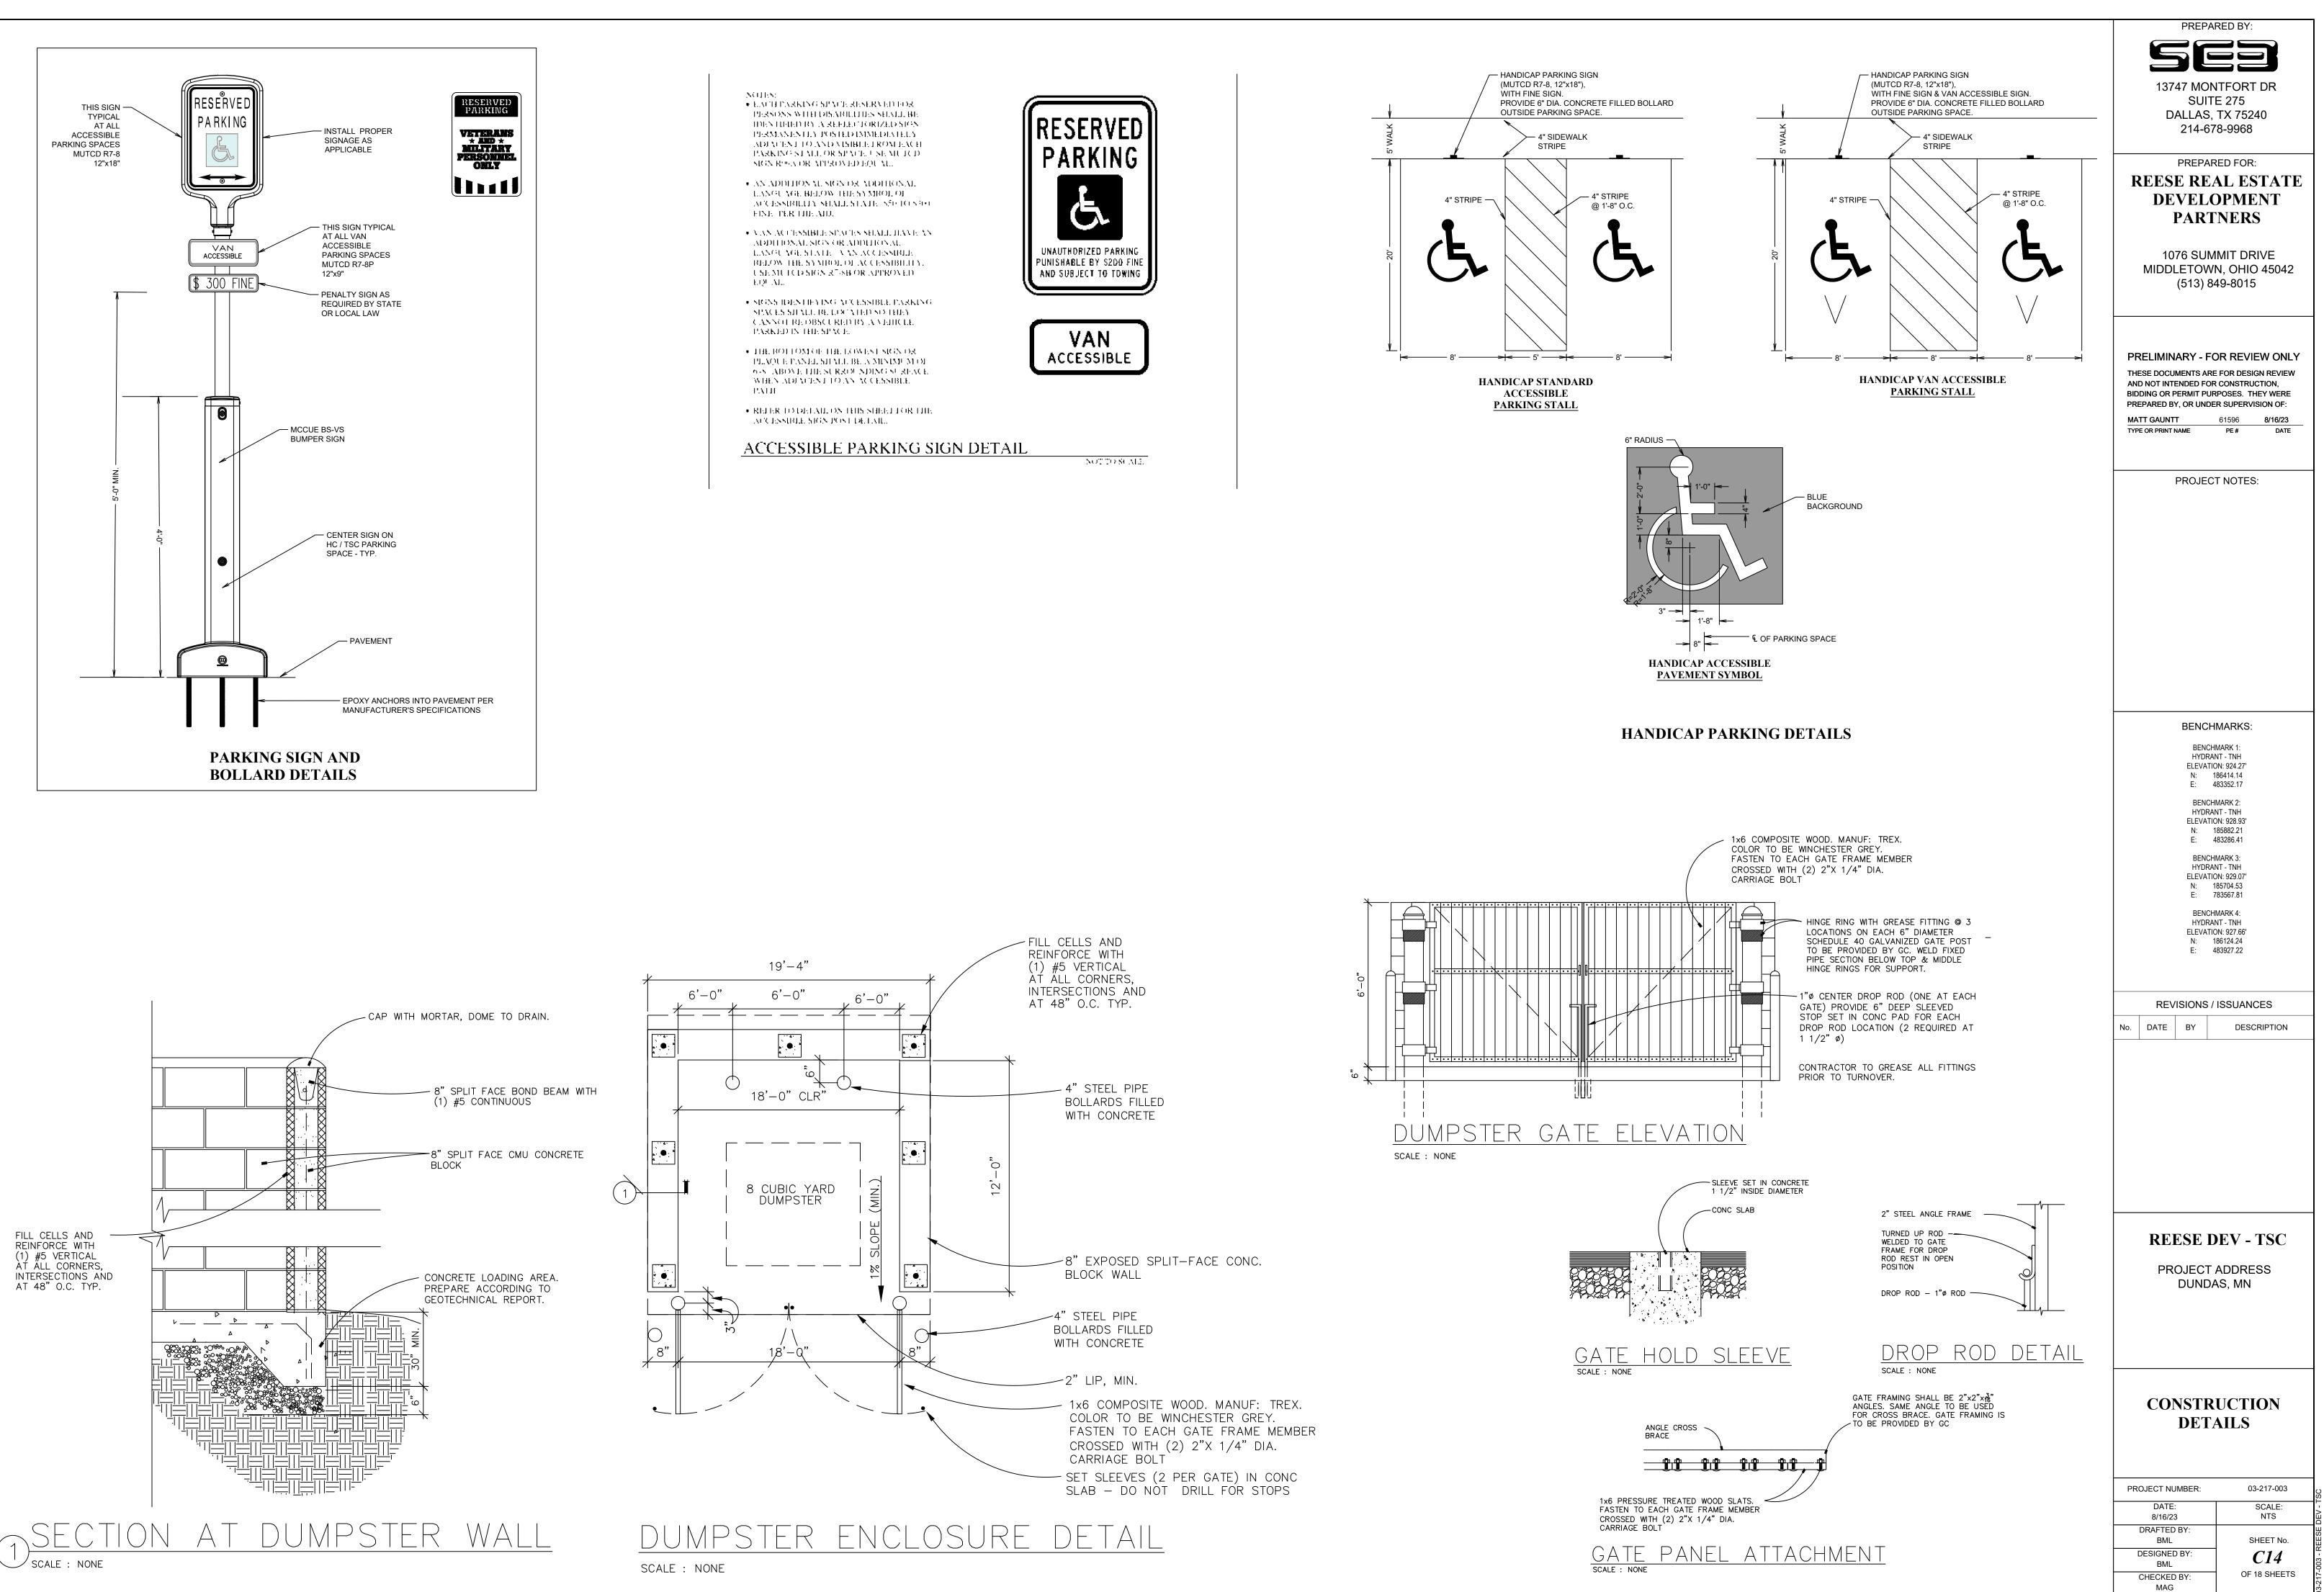





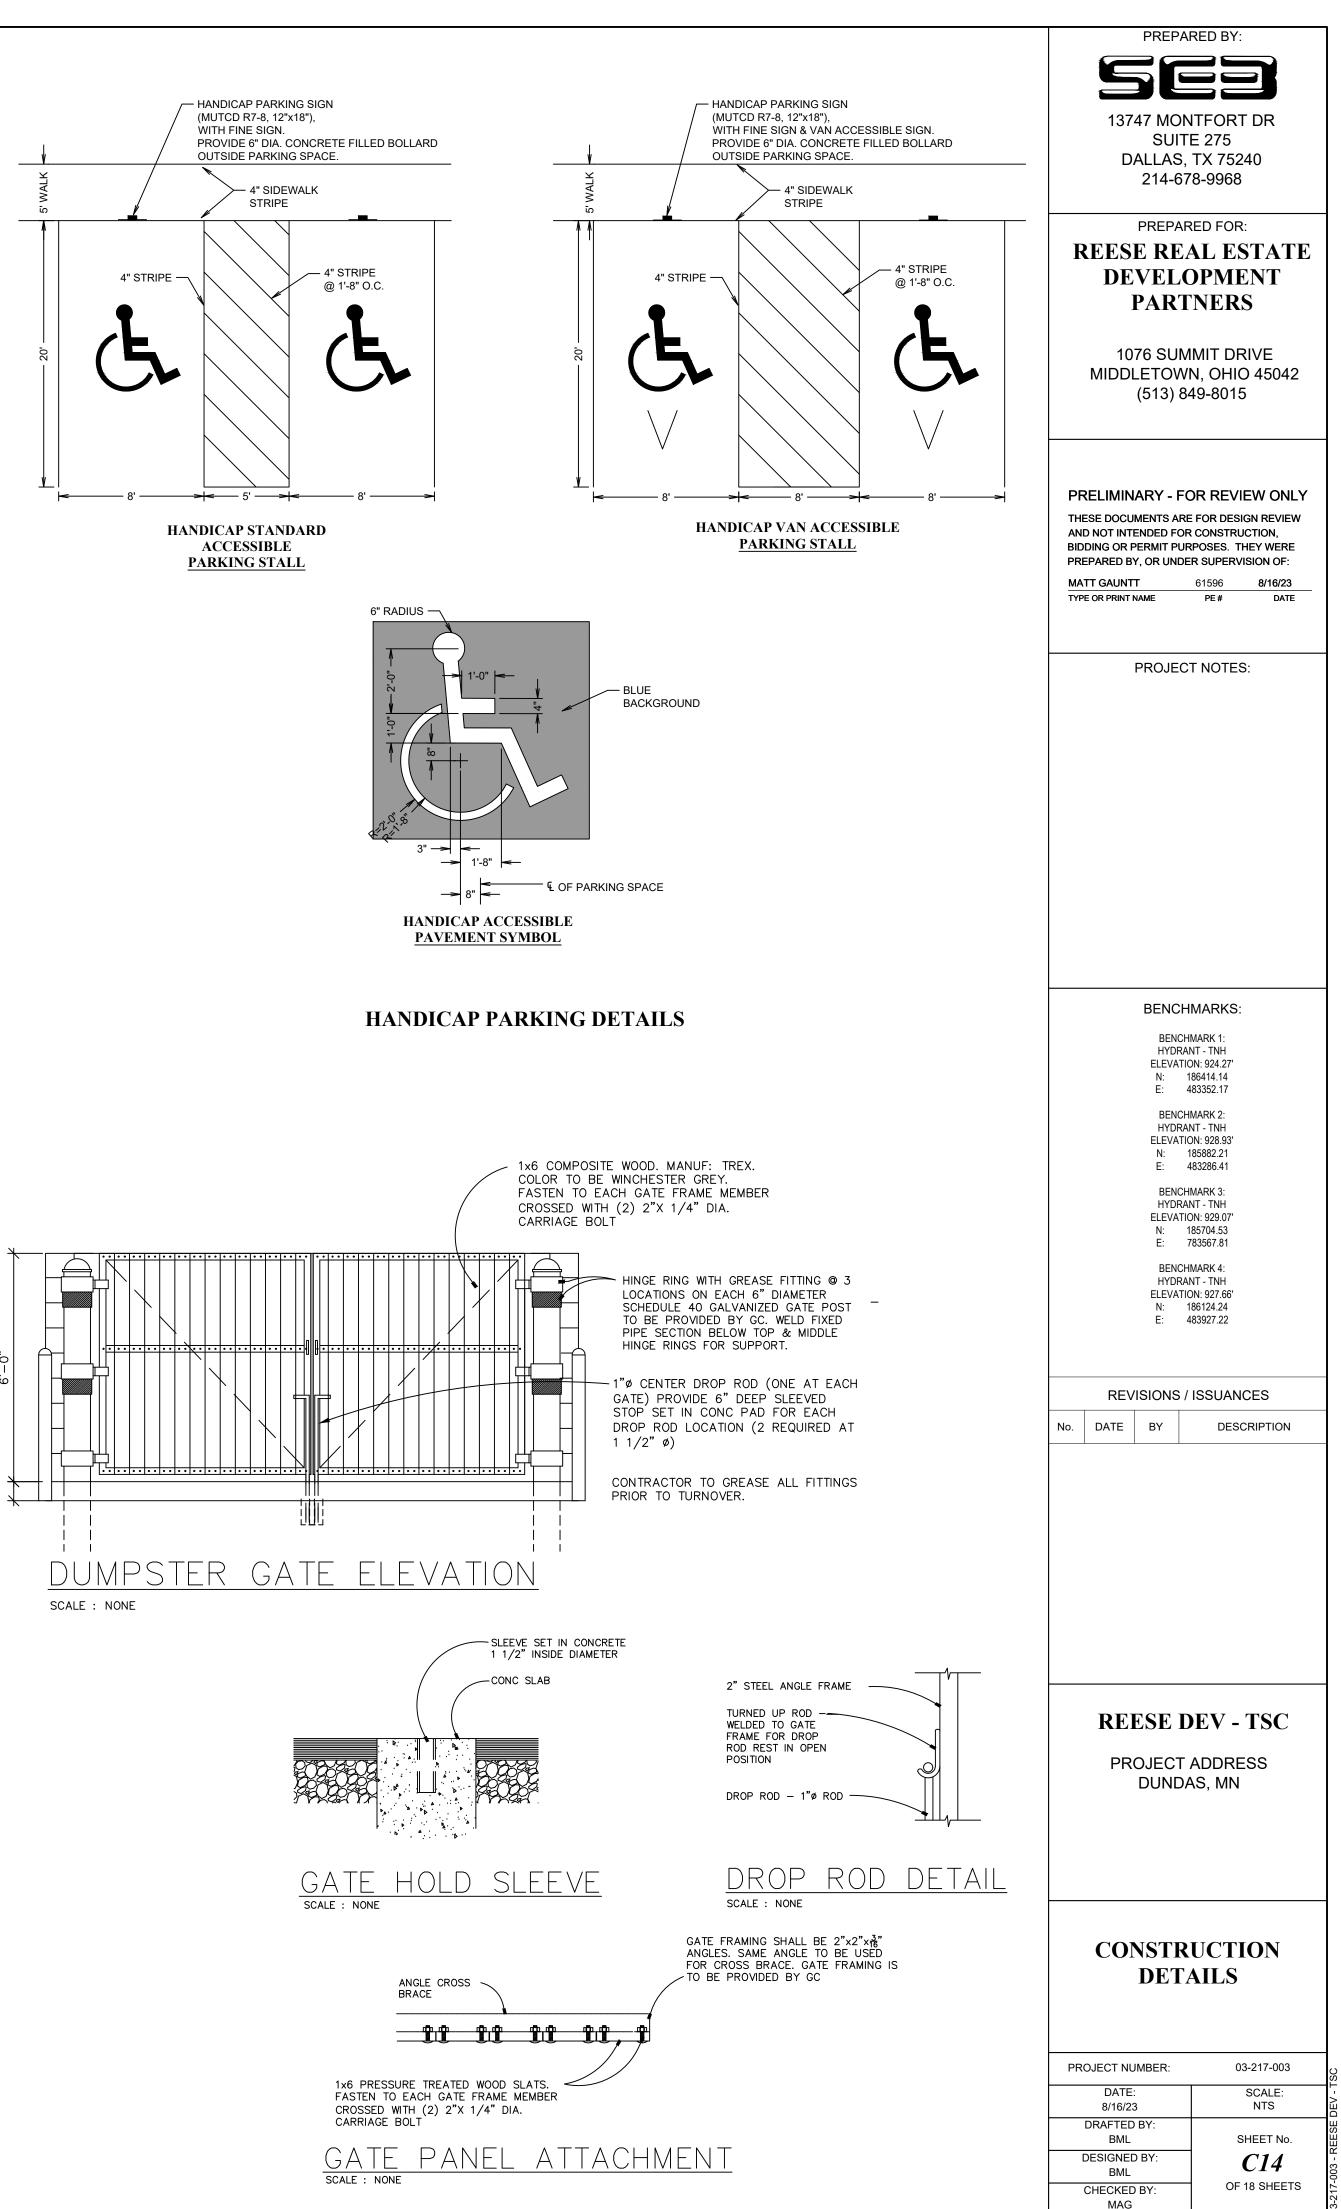



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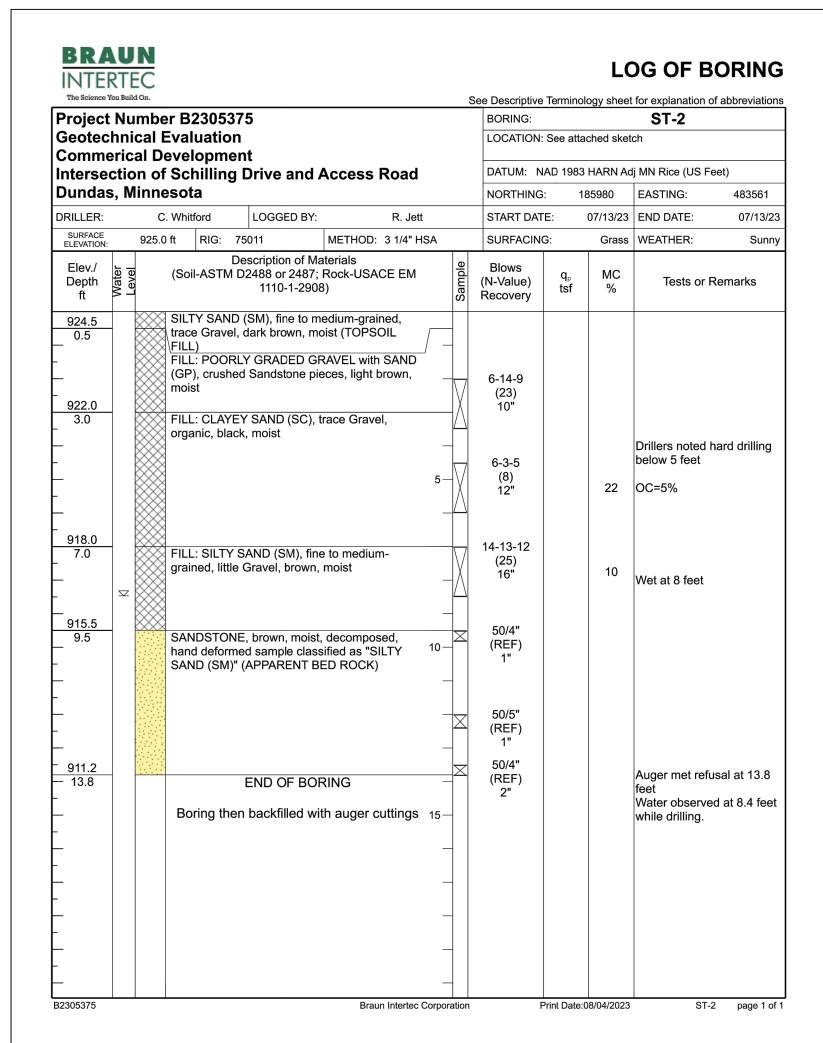
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MIDDLETOW	1MIT DRIVE N, OHIO 45042
(513) 8	49-8015
PRELIMINARY - FO	OR REVIEW ONLY
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TYPE OR PRINT NAME	PE# DATE
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PROJEC	TNOTES.
BENCH	IMARKS:
BENCH	IMARK 1:
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BENCH	483352.17 IMARK 2:
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E: •	483927.22
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	AS, MN
BORIN	G LOGS
PROJECT NUMBER:	03-217-003
DATE: 8/16/23 DRAFTED BY:	SCALE: NTS
DRAFTED BY: BML DESIGNED BY:	SHEET No. <i>C15</i>
BML CHECKED BY:	OF 18 SHEETS
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The Science Y						See Descriptive	Ferminolo	ogy sheet		of abbreviation
		r B23053				BORING:			ST-1	
		Evaluatio evelopme				LOCATION: S	See attac	ned sket	ch	
			g Drive and A	Access Roa	ad	DATUM: NA	D 1983 H	HARN Ad	j MN Rice (US F	eet)
	s, Minne		,			NORTHING:	18	5907	EASTING:	483648
ORILLER:	C.	Whitford	LOGGED BY:	R.	Jett	START DATE	: C	07/13/23	END DATE:	07/13/23
SURFACE ELEVATION:	925.8	ft RIG:	75011	METHOD: 3 1/4	1" HSA	SURFACING	:	Grass	WEATHER:	Sunn
	Water Level		Description of Ma I D2488 or 2487; 1110-1-290;	Rock-USACE E	Sample W	Blows (N-Value) Recovery	q _p tsf	MC %	Tests or	Remarks
<u>925.4</u> 0.4 - - - - - - - - - - - - - - - - - - -		trace Grave (TOPSOIL I FILL: SILTY grained, tra of Clay, dar FILL: SILTY coarse-grai SANDSTOI Limestone I classified as GRAVEL (S	D (SM), fine to m el, dark brown to FILL) SAND (SM), fin- ce Gravel, organ k brown, moist SAND with GR/ ned, brown, moise NE, light brown, r pieces, hand defo s "POORLY GRA SP)" (APPARENT END OF BOI en backfilled wi	AVEL (SM), fine for avvec (SM), f	ns to to to 10 ied,	7-8-4 (12) 12" 7-7-8 (15) 15" 40-50/2" (REF) 0" 50/0" (REF) 0" 50/4" (REF) 4" 50/1" (REF) 1"			P200=15% Drillers noted hard drilling w sample recove feet No recovery a Auger met refi feet Water not obs drilling.	ith poor ery below 7 t 10 feet usal at 13.6
_										

BRAUN INTERTEC

LOG OF BORING

	ber B230537				BORING:			ST-4	
	I Evaluation Developme				LOCATION: S	ee atta	ched sket	ch	
			Access Road		DATUM: NA	D 1983	HARN Ad	j MN Rice (US F	eet)
Dundas, Min	inesota				NORTHING:	18	36098	EASTING:	483661
DRILLER:	C. Whitford	LOGGED BY:	R. Jet	t	START DATE		07/13/23	END DATE:	07/13/2
SURFACE 92 ELEVATION: 92	24.2 ft RIG: 7	5011	METHOD: 3 1/4" H	ISA	SURFACING:		Grass	WEATHER:	Sunn
Elev./ Depth tf ft		escription of Ma D2488 or 2487; 1110-1-2908	Rock-USACE EM		Blows (N-Value) Recovery	q _₽ tsf	MC %	Tests or F	Remarks
<u>923.8</u> 0.3 - - - - - - <u>919.7</u> 4.5 - - 9 <u>17.2</u> 7.0 - - - -	Vitrace Gravel, FILL) FILL: SILTY grained, track moist FILL: Crushe	d rock, light grag	oist (TOPSOIL e to medium- / organic, black, / y		4-9-14 (23) 12" 29-50/5" (REF) 4" 50/3" (REF) 2" 50/4" (REF) 2"			Drillers noted I with poor sam below 2 feet OC=3%	
<u>- 912.0</u>	Boring the	END OF BOF	RING h auger cuttings	 15 	50/2" (REF) 2"			Water observe while drilling.	d at 12.0 fe



BRAUN INTERTEC

LOG OF BORING

Project	Nu	mbe	er B230537	75				BORING:			ST-5				
			Evaluation					LOCATION: S	See attac	ched sket	ch				
			evelopme Schilling	nt Drive and	Access	Road		DATUM: NA	D 1983	HARN Ad	j MN Rice (US F	eet)			
Dunda						louu		NORTHING:							
ORILLER:	C.	. Whitford	LOGGED BY	START DATE	:	07/13/23	END DATE:	07/13/23							
SURFACE 925.3 ft RIG: 75011 METHOD: 3 1/4" HSA								SURFACING	:	Grass	WEATHER:	Sunny			
Elev./ Depth ft	Water Level			escription of N D2488 or 2487 1110-1-290	; Rock-USA	CE EM	Sample	Blows (N-Value) Recovery	q _p tsf	MC %	Tests or F	Remarks			
924.7 _ 0.6 	Σ		FILL: POOR	(SM), fine to r dark brown, m SAND (SM), fir e Gravel, brow	noist (TOPS) ne to mediun n, moist AND with G	DIL	5-	6-7-10 (17) 10" 6-36-8 (44) 10" 50/0" (REF) 0"		9	Drillers noted I with poor sam below 5 feet No recovery at	ble recovery			
<u>915.3</u> 10.0 - -	-		Contains sea sample class	E, light brown, ams of Clay, ha ified as "POOF (APPARENT E	nd deformed RLY GRADE	d l	10-X - - - -	41-50/4" (REF) 6" 39-50/4" (REF) 6"		8					
910.8 14.5	_		Boring the	END OF BC			 15 	50/0" (REF) 0"			Water observe while drilling.	d at 7.5 feet			
-							_								

BRAUN INTERTEC The Science You Build On. Project Number B2305375 Geotechnical Evaluation Commerical Development Intersection of Schilling Drive Dundas, Minnesota DRILLER: LOGO C. Whitford SURFACE 925.1 ft RIG: 75011 Description Elev./ Level Depth T ft N T (Soil-ASTM D2488 c 1110 925.0 🔆 SILTY SAND (SM), f trace Gravel, brown, r 0.2 grained, trace Gravel, 920.6 4.5 FILL: CLAYEY SAND 🛛 brown, moist 917.7 $\sim\sim\sim\sim$ END (Boring then backfi B2305375

BRAUN INTERTEC The Science You Build On.

		nber B23053					BORING:			ST-6	
		al Evaluation I Developme					LOCATION:	See atta	iched sket	ch	
		n of Schilling		Access	Road		DATUM: N	AD 1983	HARN Ad	j MN Rice (US Fe	eet)
		nnesota					NORTHING:	1	85811	EASTING:	483532
ORILLER:		C. Whitford	LOGGED BY:		R. Jett		START DAT	E:	07/13/23	END DATE:	07/13/2
SURFACE ELEVATION:		925.8 ft RIG:	75011	METHOD:	3 1/4" HSA		SURFACING	9:	Grass	WEATHER:	Sunr
Elev./ Depth ft	Water Level		Description of Ma D2488 or 2487; 1110-1-290	Rock-USA	CE EM	Sample	Blows (N-Value) Recovery	q₀ tsf	MC %	Tests or F	Remarks
<u>_ 924.8</u> 1.1 -		trace Gravel FILL) FILL: POOR	D (SM), fine to m l, dark brown, m RLY GRADED GI coarse-grained	oist (TOPSO			19-29-17 (46) 8"			Drillers noted h with poor samp below 2 feet	
921.3 4.5		FILL: CLAYE	EY SAND (SC), f ck, moist	trace Grave	ıl, 5		4-5-5 (10) 12"		19	OC=5%	
<u>918.8</u> 7.0		FILL: CLAYE brown, mois	EY SAND (SC), † t	trace Grave	l,		19-10-5 (15) 5"				
916.3 9.5 914.8 11.0		Sandstone location classified as	IE, light brown, r enses, hand def s "CLAYEY SAN)" (APPARENT END OF BOI	ormed sam D and SILT BEDROCK)	ple ^{10 ·} Y SAND		3-4-4 (8) 12"			Water not obse drilling.	erved while
-		Boring the	en backfilled wi	th auger c	uttings						
-					15						
-						-					
-											
_				Brau		_			08/04/2023	ST-6	b page 1

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MATT GAUNTT TYPE OR PRINT NAME	61596 8/16/23 PE # DATE
PROJECT	I NOTES:
BENCH	
BENCH HYDRAN ELEVATIO	NT - TNH
	N: 924.27' 86414.14 83352.17
BENCH	MARK 2:
HYDRAN ELEVATIO N: 1	
	85882.21 83286.41
BENCH HYDRAN ELEVATIO	NT - TNH
	IN: 929.07 85704.53 83567.81
HYDRAN ELEVATIO N: 11	N: 927.66' 86124.24
E: 4	83927.22
REVISIONS /	ISSUANCES
No. DATE BY	DESCRIPTION
REESE D	EV - TSC
PROJECT	
	ADDRESS
PROJECT /	ADDRESS \S, MN
PROJECT / DUNDA	ADDRESS \S, MN
PROJECT / DUNDA	ADDRESS \S, MN
PROJECT / DUNDA	ADDRESS \S, MN
PROJECT A DUNDA	ADDRESS AS, MN G LOGS 03-217-003 SCALE:
PROJECT A DUNDA	ADDRESS S, MN G LOGS 03-217-003 SCALE: NTS
PROJECT A DUNDA BORINO PROJECT NUMBER: DATE: 8/16/23 DRAFTED BY: BML DESIGNED BY:	ADDRESS AS, MN G LOGS 03-217-003 SCALE: NTS SHEET No.
PROJECT / DUNDA BORINO	ADDRESS S, MN G LOGS 03-217-003 SCALE: NTS

LOG OF BORING

			Sac Decoriptive	Torminol	agy aboat	for ovaluation of	fabbroviations	
i			BORING:	Terminoi	logy sheet	for explanation of ST-3	appreviations	
			LOCATION:	See atta	ched sket			
e and A	Access Road		DATUM: N	AD 1983	HARN Ad	j MN Rice (US F	eet)	
			NORTHING		86002	EASTING: 483652		
GED BY:	R. Je	tt	START DAT		07/13/23	END DATE:	07/13/23	
	METHOD: 3 1/4" H	HSA	SURFACING	G:	Grass	WEATHER:	Sunny	
tion of Ma or 2487; 10-1-2908	Rock-USACE EM	Sample	Blows (N-Value) Recovery	q _⋼ tsf	MC %	Tests or F	Remarks	
i, moist (1 (SM), fine	edium-grained, FOPSOIL FILL) e to medium- ic, black, moist		, 8-9-8 (17) 14"					
ID (SC), t	race Gravel,	5-	3-4-6 (10) 18"		11	Drillers noted I below 5 feet P200=19%	nard drilling	
OF BOF	RING th auger cuttings	X 	50/4" (REF) 0"			Auger met refu feet Water not obso drilling.		
		 10						
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	Braun Intertec	: Corporatio	n P	rint Date:	08/04/2023	ST-	3 page 1 of	

LOG OF BORING

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LOG OF BORING

The Science You Build On.					5	See Descriptive	Termino	logy sheet	for explanation	of abbreviations
Project Numb	er B230537	5				BORING:			ST-7	
Geotechnical	Evaluation					LOCATION:	See atta	ched sket	ch	
Commerical D										4
Intersection of		Drive and A	Access	Road					lj MN Rice (US F	
Dundas, Minn		1				NORTHING		85920	EASTING:	483404
	C. Whitford	LOGGED BY:		R. Jett		START DAT	E:	07/13/23	END DATE:	07/13/23
SURFACE 924.	4 ft RIG: 75	5011	METHOD:	3 1/4" HSA		SURFACING	G:	Grass	WEATHER:	Sunny
Elev./ Depth are ft A		escription of Ma 2488 or 2487; 1110-1-2908	Rock-USA	CE EM	Sample	Blows (N-Value) Recovery	q _p tsf	MC %	Tests or I	Remarks
<u>924.2</u> 0.3 - - - - - - - - - - - - -	trace Gravel, I	(SM), fine to me brown (TOPSO AND with GRA d, organic laye	VEL (SM),			9-8-9 (17) 8" 8-10-17 (27) 10" 13-15-17 (32) 0"		10	Drillers noted with poor sam below 2 feet No recovery a	ple recovery
- 914.9 9.5 9.5 - 913.4 11.0 - -	hand deforme SAND and CL (APPARENT I	, light brown, m d sample class AYEY SAND" (BEDROCK) END OF BOF backfilled wit	ified as "SI (SM and SC RING	LTY 10 C)	 	19-14-28 (42) 12"			Water not obs drilling.	erved while
				15						
B2305375			Brau	n Intertec Cor		F	Print Date:	08/04/2023	ST-	7 page 1 of [,]

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LOG OF BORING


Project	Nu	mbe	r B2 3	30537	5					BORING:			ST-10	of abbreviatior
Geotec	hnio	cal E	valu	ation						LOCATION:	See atta	ched sket	ch	
				pmen [.] Iling E	t Drive and	Access	Road			DATUM: N	AD 1983	HARN Ad	j MN Rice (US F	eet)
undas				5						NORTHING	: 18	86243	EASTING:	483678
RILLER:		C.	Whitfor	ď	LOGGED BY	:	R. Jett			START DAT	E:	07/13/23	END DATE:	07/13/23
URFACE		921.9	ft F	RIG: 75	011	METHOD	: 3 1/4" H	SA		SURFACING	G:	Grass	WEATHER:	Sunny
Elev./ Depth ft	Description of Materials Description of Materials (Soil-ASTM D2488 or 2487; Rock-USACE EM 1110-1-2908)							Blows (N-Value) Recovery	q _p tsf	MC %	Tests or F	Remarks		
9 <u>17.4</u> 0.5 0 <u>17.4</u> 4.5 9 <u>12.0</u> 9.9			SAND GRAD BEDR	STONE, posed, l ned sam ED SAN OCK)	SM), fine to f lark brown, r AND with GF d, brown, mo light brown Limestone pi ple classified ID" (SP) (AP	to white, model (SM) ist to white, model (SM) eces, hand as "POOF PARENT	SOIL , fine to Dist, RLY			6-8-9 (17) 5" 50/2" (REF) 2" 50/4" (REF) 4" 50/5" (REF) 3"		5	Drillers noted f below 2 feet Water not obse drilling.	J
								_						
305375						Bra	un Intertec (Corporatio	n n	F	Print Date:	08/04/2023	ST-10	D page 1 of

BRAUN	
INTERTEC	LOG OF BORING
	See Descriptive Terminology sheet for explanation of abbreviations
Project Number B2305375	BORING: ST-8
Geotechnical Evaluation Commerical Development	LOCATION: See attached sketch
Intersection of Schilling Drive and Access Road	DATUM: NAD 1983 HARN Adj MN Rice (US Feet)
Dundas, Minnesota	NORTHING: 186058 EASTING: 483501
DRILLER: C. Whitford LOGGED BY: R. Jett	START DATE: 07/13/23 END DATE: 07/13/23
SURFACE 923.3 ft RIG: 75011 METHOD: 3 1/4" HSA	SURFACING: Grass WEATHER: Sunny
Elev./ DepthDescription of Materials (Soil-ASTM D2488 or 2487; Rock-USACE EM 1110-1-2908)Description of Materials 	Blows (N-Value) q _p MC (N-Value) tsf % Tests or Remarks
SILTY SAND (SM), fine to coarse-grained, little 921.3 2.0 FILL: SANDY LEAN CLAY (CL), trace Gravel, slightly organic, black, moist FILL: SILTY SAND with GRAVEL (SM), fine to coarse-grained, brown, wet	4-6-10 16) 15 OC=4% 10-4-9 15 OC=4% 10-4-9 15 Drillers noted hard drilling with poor sample recovery below 7 feet 4-9-14 C3) 4" No recovery at 10 feet Water observed at 7.0 feet while drilling. 50/2" No Intervention of the second
B2305375 Braun Intertec Corporation	Print Date:08/04/2023 ST-8 page 1 of 1

BRAUN INTERTEC

LOG OF BORING

	See Descriptive	e Terminology sl	neet for explanation	n of abbreviations
Project Number B2305375	BORING:		ST-11	
Geotechnical Evaluation Commerical Development	LOCATION	: See attached	sketch	
Intersection of Schilling Drive and Access Road	DATUM: N	IAD 1983 HARI	NAdj MN Rice (US	Feet)
Dundas, Minnesota	NORTHING	6: 186217	EASTING:	483763
DRILLER: C. Whitford LOGGED BY: R. Jett	START DAT	TE: 07/13	/23 END DATE:	07/13/23
SURFACE 923.5 ft RIG: 75011 METHOD: 3 1/4" HSA	SURFACIN	G: Gr	ass WEATHER:	Sunny
Elev./ DepthDescription of Materials (Soil-ASTM D2488 or 2487; Rock-USACE EM 1110-1-2908)Description of Materials 	Blows (N-Value) Recovery	q _p M tsf %		r Remarks
923.1 0.3 - 0.3 - - - - - - - - - - - - -	4-6-7 (13) 13"	8	with poor sar below 2 feet	d hard drilling nple recovery
919.0 4.5 GRAVEL (SP-SM), fine to coarse-grained, light 5 brown, moist	11-9-17 (26) 14"			
	50/1" (REF) 0"		No recovery	at 7 feet
	50/4" (REF) 0"		No recovery	at 10 feet
- <u>911.2</u> - 12.3 - Boring then backfilled with auger cuttings	50/3" (REF) 0"		No recovery Water not ob drilling.	
15				
-				
-				
B2305375 Braun Intertec Corporation	F	Print Date:08/04/2	023 ST	-11 page 1 of 1

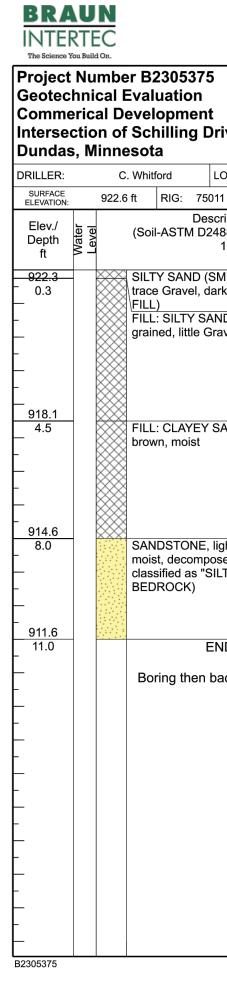

BRAUN INTERTEC


Commerica ntersectio	al Develo n of Schi	pment Illing Dr	ive and A				LOCATION: S	See atta	iched sket	ch	
ntersectio Dundas, M DRILLER: SURFACE ELEVATION: Elev./ Depth	n of Schi innesota	İling Dr	ive and A			Geotechnical Evaluation Commerical Development					
Dundas, M DRILLER: SURFACE ELEVATION: Elev./ Depth	innesota		ive and A	ccess	Road		DATUM: NA	D 1983	HARN Ad	j MN Rice (US Fe	et)
Elev./	C. Whitfo		tersection of Schilling Drive and Access Road undas, Minnesota						86125	EASTING:	483797
ELEVATION: Elev./ Depth age		rd L	OGGED BY:		R. Jett		START DATE	:	07/13/23	END DATE:	07/13/23
Depth te a	924.7 ft F	RIG: 7501	1	METHOD:	3 1/4" HS	SA	SURFACING		Grass	WEATHER:	Sunn
i i i i i i i i i i i i i i i i i i i		ASTM D24	ription of Mat 88 or 2487; F 1110-1-2908;	Rock-USA()		Sample	Blows (N-Value) Recovery	q _⋼ tsf	MC %	Tests or F	Remarks
$ \begin{array}{c} 924.2 \\ 0.6 \\ - \\ - \\ - \\ - \\ - \\ - \\ - \\ - \\ - \\ -$	FILL: graine FILL: graine FILL: coarse SAND decon deforr GRAE (APPA	Gravel, dar SILTY SAN d, little Gra SILTY SAN e-grained, STONE, lin ned sample DED SAND NRENT BE	 A), fine to me k brown, moi ID (SM), fine avel, brown, r ID with GRAV ID with GRAV brown, moist ght brown, m e classified a WITH SILT" DROCK) ID OF BOR ackfilled with 	ist (TOPS(to coarse- noist /EL (SM), /EL (SM), oist to wett es, hand s " POORI (SP-SM)	OIL		7-10-27 (37) 4" 7-7-7 (14) 10" 50/5" (REF) 4" 50/5" (REF) 4" 50/1" (REF) 0"		5	Drillers noted h with poor samp below 5 feet P200=14% No recovery at Water observe while drilling.	ole recovery
-						_					

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TYPE O	R PRINT NAME	PE#	DATE
	PROJI	ECT NOTE	S:
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	HYE ELEV N:	NCHMARK 1: DRANT - TNH ATION: 924.27' 186414.14	
		483352.17 NCHMARK 2: DRANT - TNH	
		ATION: 928.93' 185882.21	
	HYE ELEV	NCHMARK 3: DRANT - TNH ATION: 929.07'	
		783567.81 NCHMARK 4:	
	ELEV N:	DRANT - TNH ATION: 927.66' 186124.24 483927.22	
No. [REVISION		
	REESE PROJEC		
		DAS, MN	
	BORIN	NG LO	GS
PROJI	ECT NUMBER:		03-217-003
DR	8/16/23 AFTED BY:		SCALE: NTS
DE	BML SIGNED BY: BML		SHEET No. <i>C17</i>
СН	ECKED BY: MAG	0	F 18 SHEETS

LOG OF BORING

	Se	e Descriptive	Terminol	ogy sheet	for explanation o	fabbreviations
5		BORING:			ST-9	
t	LOCATION: See attached sketch					
τ Drive and Access Road		DATUM: N	AD 1983	HARN Ad	j MN Rice (US Fe	et)
		NORTHING	: 18	36168	EASTING:	483600
LOGGED BY: R. Jett		START DAT	E:	07/13/23	END DATE:	07/13/23
011 METHOD: 3 1/4" HSA		SURFACING	G:	Grass	WEATHER:	Sunny
scription of Materials 2488 or 2487; Rock-USACE EM 1110-1-2908)		Blows (N-Value) Recovery	q _p tsf	MC %	Tests or F	Remarks
SM), fine to medium-grained, lark brown, moist (TOPSOIL AND (SM), fine to medium- Gravel, black, moist		6-8-9 (17) 10"			Drillers noted h below 2 feet	ard drilling
SAND (SC), trace Gravel, 5-		6-8-8 (16) 12"				
light brown to orangish brown, bosed, hand deformed sample SILTY SAND" (SM) (APPARENT —		7-8-7 (15) 18"		14	P200=23%	
10-		4-8-14 (22) 18"			Water not obse	erved while
END OF BORING backfilled with auger cuttings [—] –	-				drilling.	
 15	-					
_	-					
-						
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Braun Intertec Corpor	ation	F	Print Date:0	8/04/2023	ST-9	page 1 of 1

LOG OF BORING

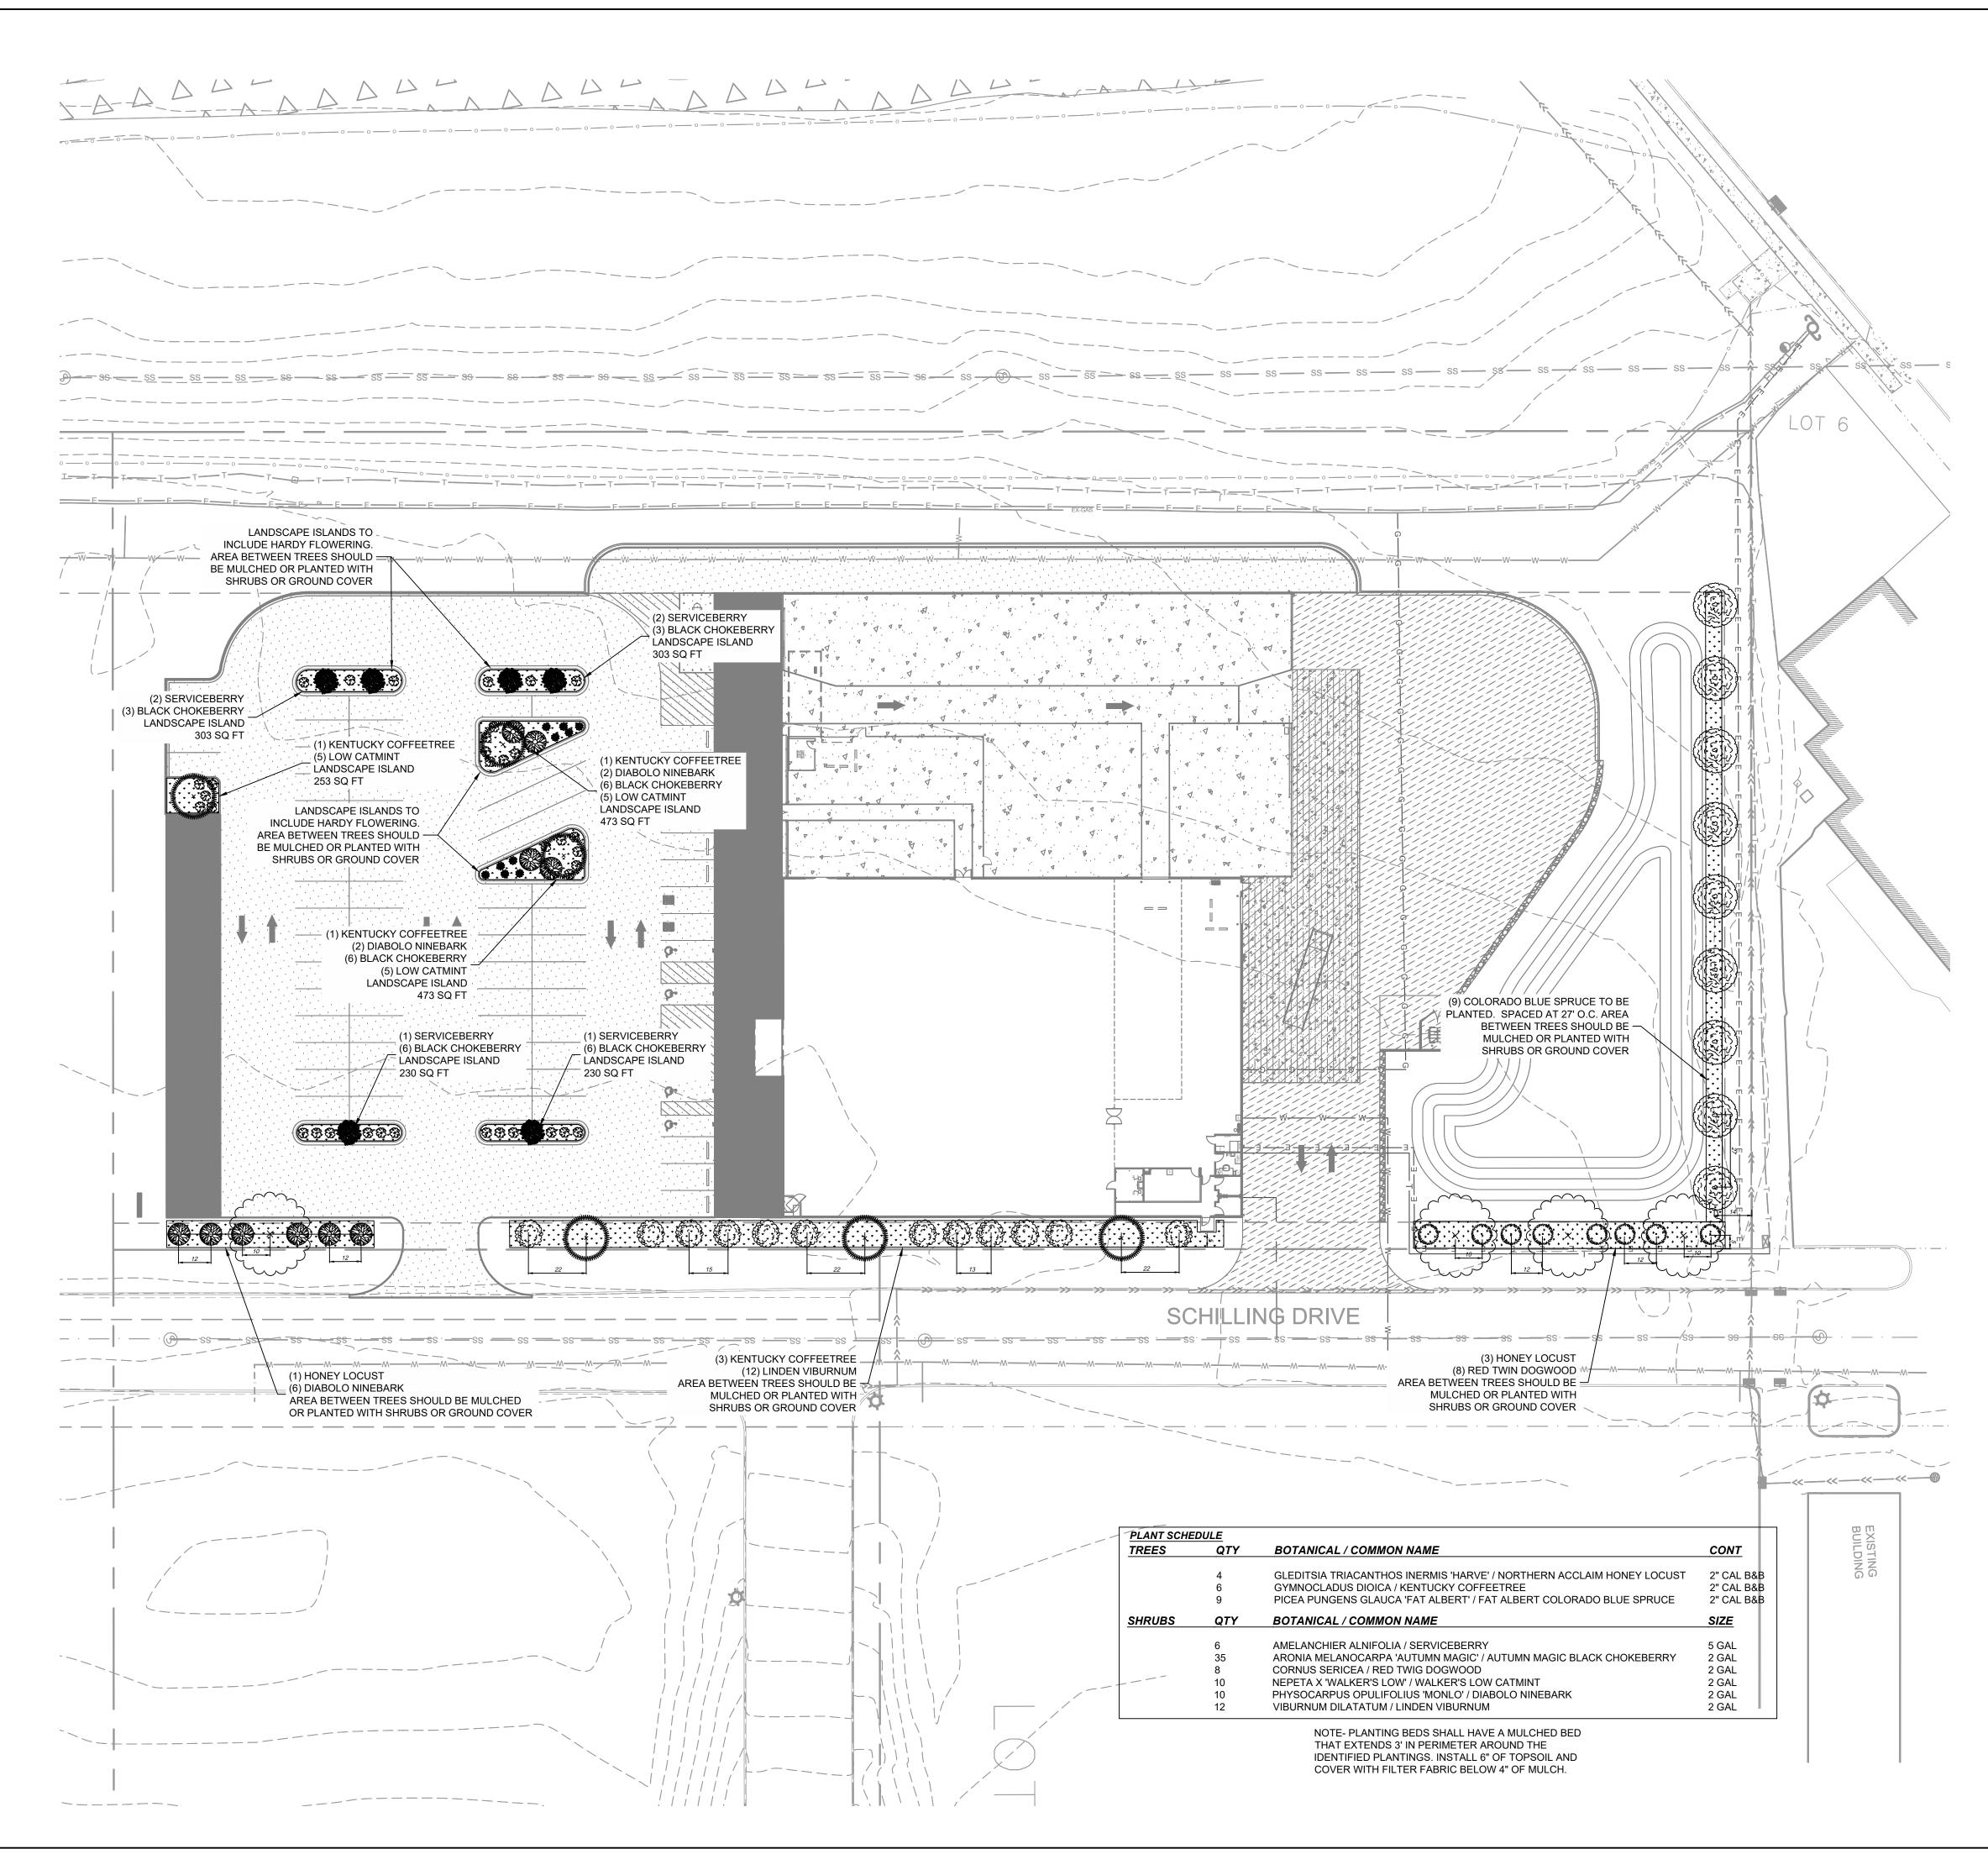

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DALLAS, TX 75240 214-678-9968 PREPARED FOR: REESE REAL ESTATE DEVELOPMENT PARTNERS 1076 SUMMIT DRIVE MIDDLETOWN, OHIO 45042 (513) 849-8015 PRELIMINARY - FOR REVIEW ONLY INDES DOCUMENTS ARE FOR DESIGN REVIEW AND NOT INTENDED FOR CONSTRUCTION, BIDDING OR PRIMT PURPOSES. THEY WERE PREPARED BY, OR UNDER SUPERVISION OF: MATT GAUNT MATT GAUNT PREJECT NOTES: BENCHMARKS: HEYDRINT. THH ELEVITON 292 27 BENCHMARK 1: HYDRAMT. THH ELEVITON 292 27 BENCHMARK 2: HYDRAMT. THH BENCHMARK 2: HYDRAMT. THH BE		-
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STREET TREES

- A. TREES ARE TO BE PURCHASED ONLY FROM NURSERIES IN NORTHERN REGIONS WHICH ARE COMPATIBLE WITH THE CLIMATE OF THE CITY OF DUNDAS. ALL PLANT MATERIAL SHALL BE TRUE TO NAME AND TYPE, AND FIRST-CLASS REPRESENTATIVES OF THEIR SPECIES OR VARIETY. THEY SHALL HAVE NORMAL, WELL DEVELOPED BRANCHES, BE HEALTHY, VIGOROUS PLANTS FREE FROM DISFIGUREMENTS. EITHER BARE ROOT OR BALLED AND BURLAPED TREES ARE ACCEPTABLE. ALL PLANT MATERIAL SHALL CONFORM TO AMERICAN STANDARD FOR NURSERY STOCK.
- B. THE STREET TREES SHALL BE CENTERED BETWEEN THE BACK OF THE CURB AND THE STREET SIDE OF THE EXISTING OR FUTURE SIDEWALKS. THE TREES SHALL ALSO BE LOCATED FIVE (5) FEET FROM ALL SEWER AND WATER LATERALS, AND TEN (10) FEET FROM DRIVEWAYS, LIGHT POLES AND FIRE HYDRANTS. NO STREET TREES SHALL BE PLANTED WITHIN 35 FEET OF ANY STREET CORNER, MEASURED FROM THE POINT OF NEAREST INTERSECTING CURB LINES.
- C. ALL STREET TREES PLANTED SHALL BE OF MINIMUM SIZE OF 2" CALIPER. SAID CALIPER READING SHALL BE TAKEN 6" ABOVE THE GROUND SURFACE.
- D. THE SIZE FOR THE TREE INSTALLATION HOLE SHALL BE A MINIMUM OF 36" IN DIAMETER. TREES SHALL BE PLANTED WITH THE ROOT COLLAR AT SURFACE LEVEL. FOR BALLED TREES, THE HOLE SHALL BE 18" LARGER THAN THE LARGEST DIAMETER OF THE BALL AND NO DEEPER THAN THE BALL.
- E. SOIL FOR BACKFILLING AROUND ROOTS AND/OR ROOT BALLS SHALL BE THE EXISTING SOIL FROM THE EXCAVATION. WHERE EXISTING SOIL IS ROCKY AND POOR QUALITY, THE LOCAL BROWN TOPSOIL MAY BE USED. SOIL SHALL BE PULVERIZED AND SCREENED. ALL MATERIAL DUG FROM THE PLANT HOLES AND NOT USED SHALL BE REMOVED FROM THE SITE AND DISPOSED OF. IMMEDIATELY AFTER PLANTING, SOIL AROUND ROOTS AND BALLS SHALL BE THOROUGHLY WATERED.
- F. AT THE TIME OF PLANTING, TREES SHALL BE PRUNED TO REMOVE DEAD, BROKEN, OR DISEASED BRANCHES OR CROSS BRANCHES THAT MAY RUB. AS MUCH OF THE CROWN AS POSSIBLE SHALL BE MAINTAINED TO CREATE FOOD FOR THE TREE. TREES SHALL APPEAR SYMMETRICAL IN SHAPE AND APPEARANCE.
- G. PERSONS INSTALLING STREET TREES SHALL TAKE ALL NECESSARY PRECAUTIONS TO MINIMIZE THE DAMAGE TO EXISTING LAWNS. ANY DAMAGE TO EXISTING LAWNS SHALL BE REPAIRED BY PLACING TOPSOIL AND SEED IN THE DAMAGED AREA.
- H. UPON COMPLETION OF PLANTING, INDIVIDUAL PLANT HOLES SHALL BE OUTLINED WITH A SHOULDER OF SOIL PLACED OUTSIDE OF RIM OF HOLES TO FORM A SAUCER. WOOD MULCH MATERIAL SHALL BE PLACED TO COVER DISTURBED AREA TO A MINIMUM DEPTH OF FOUR (4) INCHES, BUT THERE WILL BE AN AIR GAP 1" WIDE AROUND THE TRUNK WITH NO MULCH.
- STREET TREES SHALL BE STAKED WITHIN ONE WEEK OF PLANTING, UNLESS THE CITY FORESTER WAIVES THIS DUE TO SIZE OR SPECIES, WITH A MINIMUM OF TWO WOOD POSTS THAT HAVE A MINIMUM DIAMETER OF 2-1/2 INCHES. THE MINIMUM LENGTH OF THE POSTS SHALL BE THE DEPTH OF THE BORE PLUS ONE-HALF THE HEIGHT OF THE TREE. THE POSTS SHALL BE INSTALLED AT LEAST ONE FOOT OUTSIDE THE DIAMETER OF THE TREE-PLANTING HOLE. THE TREE SHALL BE CONNECTED TO THE POSTS WITH A 2" X 1/16" STRAP OF SUCH DESIGN SO AS NOT TO DAMAGE THE TREE. THE TREE SHALL BE PLANTED AS PLUMB AS POSSIBLE AND THE CONTRACTOR SHALL MAINTAIN TREE PLUMBNESS THROUGHOUT THE GUARANTEE PERIOD. ALL STAKES SHALL BE REMOVED WITHIN ONE YEAR OF PLANTING.
- J. STREET TREES PLANTED BETWEEN JUNE 15 AND SEPTEMBER 15 SHALL BE BALLED AND BURLAPED.
- K. ALL INSTALLATION MUST BE INSPECTED BY THE CITY FORESTER, OR A REPRESENTATIVE. IF, IN THE SOLE OPINION OF THE CITY FORESTER, ADDITIONAL REMEDIES ARE NEEDED TO ASSURE THE STOCKING AND MAINTENANCE OF HEALTHY TREE SPECIMENS, ADDITIONAL REMEDIES MAY BE REQUIRED.
- L. STREET TREES INSTALLED BY THE CITY UNDER THESE SPECIFICATIONS SHALL BE GUARANTEED FOR ONE (1) GROWING SEASON. REPLACEMENT TREES UNDER THIS SECTION SHALL ALSO BE GUARANTEED FOR ONE (1) GROWING SEASON. REPLACEMENT OF TREES BEYOND THIS Two (2) YEAR PERIOD SHALL BE THE RESPONSIBILITY OF THE PROPERTY OWNER.

PARKING LOT LANDSCAPING

- 1) AMOUNT REQUIRED. IN PARKING LOTS, AT LEAST FIVE PERCENT (5%) OF THE INTERIOR PARKING AREA SHALL BE LANDSCAPED.
- 2) LOCATION. THE LANDSCAPING SHOULD BE LOCATED IN PROTECTED AREAS, SUCH AS ALONG WALKWAYS, IN RAISED CENTER ISLANDS PROTECTED BY CURB AND GUTTER, AT THE ENDS OF BAYS PROTECTED BY CURB AND GUTTER, OR BETWEEN PARKING STALLS. ALL LANDSCAPING IN PARKING AREAS AND ON THE STREET FRONTAGE SHALL BE PLACED SO THAT IT WILL NOT OBSTRUCT SIGHT DISTANCE.
- 3) AREAS BETWEEN TREES SHALL BE MULCHED OR PLANTED WITH SHRUBS OR GROUND COVER. ANY LANDSCAPED AREA THAT WILL BE UNDER THE OVERHANG OF VEHICLES SHALL BE MULCHED OR COVERED WITH DECORATIVE PAVING MATERIAL.

PARKING LOT LANDSCAPE

LANDSCAPE AREA

5% OF INTERIOR PARKING AREA SHOULD BE LANDSCAPED

43,089.5 SQ FTPARKING AREA2,154.5 SQ FTREQUIRED LANDSCAPING AREA2,265.0 SQ FTPROVIDED LANDSCAPING AREA

PLANNING REPORT

TO:	Dundas City Council Dundas Planning Commission Jenelle Teppen, City Administrator
FROM:	Nate Sparks, City Planner
DATE:	August 25, 2023
RE:	Comprehensive Plan & Zoning Updates – Commercial Uses

BACKGROUND

Recently, the City adopted some new ordinance language related to the Comprehensive Plan. When reviewing these changes, the City Attorney had some recommendations.

One such recommendation was to split the Highway Commercial land use designation into two. One for properties adjacent to the Highway and one for properties a tier off. The properties in the second tier could be utilized for more expansive uses than just the retail commercial / auto service type uses found typically in this corridor.

Then the City could create a zoning district that more explicitly allows for uses such as commercial recreation (like the Dundas Dome) and churches (like Canvas Church next to the theater). The current code language for these types of uses is in need of amendment.

PROPOSED AMENDMENTS

The following changes are proposed:

Comp Plan

Being added to the comp plan is a new land use designation that is the General Business designation. This is intended to be for a wider array of uses than the retail based Highway Commercial land use.

Zoning Definitions

The code lacks a definition of indoor commercial recreation and utilizes and out of date definition for places of worship.

Conditional Uses

The ordinance then states that Places of Worship are permitted within the R-2 (where one currently exists), R-4, and B-3 (where one currently exists) Districts as a CUP.

Lot Width/Area

There was no requirement for lot width or area in the B-2 District. This has been added.

B-3 District

A new B-3, General Business District has been added. This allows for a mix of commercial, assembly, and institutional uses, as opposed to the B-2 District which is more geared for retail commercial uses. It is then placed on the map in the same location as the General Business Land Use Designation (one tier off of Highway 3).

RECOMMENDATION

Staff would recommend approval of the above amendments after an informative discussion.

CITY OF DUNDAS COUNTY OF RICE STATE OF MINNESOTA

RESOLUTION 2023-___

RESOLUTION APPROVING A COMPREHENSIVE PLAN AMENDMENT TO INCLUDE THE GENERAL BUSINESS LAND USE DESIGNATION

WHEREAS, the City of Dundas recently reviewed the Comprehensive Plan in relation to commercial land uses; and

WHEREAS, the City is seeking to amend the Comprehensive Plan to include a General Business Land Use designation within the text of the document and on the map; and

WHEREAS, the Planning Commission held a duly-noticed public hearing on August 28, 2023; and

WHEREAS, Chapter 6 of the Comprehensive Plan is amended to include the following text under the Commercial Land Use heading:

General Commercial

This designation is intended to provide for a mix of general commercial, office, assembly, commercial recreation, educational, and other such uses. These uses may not dependent upon highway frontage to the extent of the uses found within the Highway Commercial designation. The development style in this designation is intended to be similar to that of the Highway Commercial land use but will allow for a wider range of uses. Site design and parking provision will need to be accounted for within this designation. Non-retail uses may be permitted provided they are similar in nature to the uses listed above.

WHEREAS, the future land use map found within Chapter 6 is amended as found in the map attached as Exhibit A; and

NOW, THEREFORE, BE IT RESOLVED, by the City Council of the City of Dundas amends the Comprehensive Plan as identified herein and directs Staff to update the document.

ADOPTED by the Dundas City Council this 28th day of August 2023.

City of Dundas

By: _____

Glenn Switzer, Mayor

Attest:

By: ______ Jenelle Teppen, City Administrator/Clerk

Attached: Exhibit A – Land Use Map

ORDINANCE 2023 – 07

CITY OF DUNDAS COUNTY OF RICE STATE OF MINNESOTA

An Ordinance Amending Chapter 154 Related to the Adoption of the B-3, General Business District and Modifications to Non-retail Uses in the B-2 District

THE CITY COUNCIL OF THE CITY OF DUNDAS DOES ORDAIN: SECTION 1. Section 154.008 is hereby amended to delete the definition of Religious Institution and add the following definitions:

COMMERCIAL RECREATION - INDOOR. A bowling alley, car track, jump center, golf, pool hall, vehicle racing or amusement, dance hall, skating, trampoline, fire arms range, amusement ride, and similar uses whose activities occur inside a building.

PLACE OF WORSHIP. A building, together with its accessory buildings and uses, where persons assemble at regular intervals for religious worship and which building, together with its accessory buildings and uses, is maintained and controlled by a religious body organized to sustain public worship, including, but not limited to, churches, chapels, temples, mosques, and synagogues. Examples of accessory uses for a place of worship include, but are not limited to, classrooms for religious instruction, kitchens, banquet and meeting rooms, and offices in support of the worship use. Examples of auxiliary uses which are not considered a place of worship: coffee shops, day cares, restaurants, outdoor sports or recreational complexes, retreat homes, publishing establishments, schools, hospitals, and chemical dependency treatment centers.

SECTION 2. Section 154.089 (D) (2) is hereby amended to read as follows:

(2) Conditional uses in this district include: none

SECTION 3. Section 154.090 (D) (2) is hereby amended to read as follows:

(2) Conditional uses in this district include:

(a) Places of Worship, conditioned on access being provided only off of a collector road; and

(b) Bed and breakfast facilities.

SECTION 4. Section 154.090 (D) (2) is hereby amended to read as follows:

(2) Conditional uses in this district include:

(a) Manufactured Home Parks subject to the performance standards of this District.

SECTION 5. Section 154.091 (D) (2) is hereby amended to read as follows:

(2) Conditional uses in this district include:

- (a) Public or semi-public recreational or community buildings
- (b) Places of Worship, conditioned on access being provided only off of a collector road
- (a) Manufactured home parks subject to the performance standards of the R-3 District
- (b) Nursing homes/assisted living facilities
- (c) Chemical dependency treatment centers
- (d) Public or private schools

SECTION 6. Section 154.095 (B) (5) is hereby deleted.

SECTION 7. Section 154.095 (B) (15) is hereby amended to read as follows:

(15) Public/Government Offices

SECTION 8. Section 154.097 (B) is hereby amended to read as follows:

(B) Permitted uses. Permitted uses in the B-2 District include:

(1) Day care center

(2) Retail centers and commercial office buildings. Development of individual and/or groups of buildings that are 80,000 square feet (individually and cumulatively) and larger require zoning as PUD. Expansions of existing buildings over 80,000 square feet or expansions resulting in buildings that are 80,000 square feet (individually and cumulatively) also require zoning as a PUD. The projects will be evaluated based on the design guidelines in §§ 154.115 through 154.128 of this chapter;
(3) All permitted uses allowed in the B-1A District; and

SECTION 9. Section 154.097 (D) (2) (c) is hereby deleted.

SECTION 10. Section 154.097 (E) is hereby amended to read as follows:

(E) Performance standards. The following minimum requirements shall be observed in the B-2 District:

(1) Lot area: 15,000 square feet;

(2) Lot width: 75 feet;

(3) Setbacks:

(a) Front yards: not less than 25 feet. In the case of corner lots, two front yards will be

required.

(b) Side yards: not less than ten feet on each side, except where there is a permissible zero lot line setback pursuant to division (D)(2)(a) above or 25 feet when abutting a public right-of-way or a residential district; and (c) Rear yards: not less than 25 feet.

(4) Impervious surface maximum: 65%

SECTION 11. Section 154.098 is hereby amended to read as follows with the existing sections 154.098 through 154.104 being renumbered to 154.099 to 154.105:

§ 154.098 B-3, GENERAL COMMERCIAL DISTRICT.

(A) Purpose. The B-3, General Commercial District is intended to provide for the development of general business, assembly, office, and similar uses. The District is located on the periphery of the retail commercial oriented areas.

(B) Permitted uses. Permitted uses in the B-3 District include:

- (1) Adult education/vocational schools
- (2) Banquet halls/conference centers
- (3) Club or lodge
- (4) Commercial recreation indoor
- (5) Day care center
- (5) Funeral home
- (6) Library
- (7) Theater

(8) Retail centers and commercial office buildings. Development of individual and/or groups of buildings that are 80,000 square feet (individually and cumulatively) and larger require zoning as PUD. Expansions of existing buildings over 80,000 square feet or expansions resulting in buildings that are 80,000 square feet (individually and cumulatively) also require zoning as a PUD. The projects will be evaluated based on the design guidelines in §§ 154.115 through 154.128 of this chapter;
(9) All permitted uses allowed in the B-1A District.

(9) All permitted uses anowed in the B-1A District.

(C) Accessory uses. Permitted accessory uses in the B-2 District are those commercial or business buildings and structures accessory to the principal use. The accessory uses shall not exceed 30% of the gross floor space of the principal use.

(D) Conditional uses.

(1) Conditional uses in this district are subject to the following requirements:

(a) A conditional use permit is applied for based on procedures set forth in § 154.022 of this chapter;

(b) Screening and landscaping in compliance with § 154.071 of this chapter shall be required; and

(c) Off-street parking is provided in compliance with § 154.067 of this chapter.(2) Conditional uses in this district include:

(a) Commercial developments undertaken by two or more property owners in which the extension of an existing structure is proposed, a new structure is proposed, or a structure spans more than one lot. Side yards shall not be required (a zero lot line setback) in these cases unless the side yard abuts residentially zoned property or a public road. Side yard requirements specified below shall apply in these areas;

(b) Accessory adult uses as defined in Ch. 117 of this code; and

(c) Places of Worship, conditioned on access being provided only off of a collector road

(d) Motor Fuel Station

(e) Auto Sales

(f) Car Wash

(g) Auto Repair Facility – Minor

(h) Public or private school

(E) Performance standards. The following minimum requirements shall be observed in the B-2 District:

(1) Lot area: 15,000 square feet;

(2) Lot width: 75 feet;

(3) Setbacks:

(a) Front yards: not less than 25 feet. In the case of corner lots, two front yards will be

required.

(b) Side yards: not less than ten feet on each side, except where there is a permissible zero lot line setback pursuant to division (D)(2)(a) above or 25 feet when abutting a public right-of-way or a residential district; and (c) Rear yards: not less than 25 feet.

(4) Impervious surface maximum: 65%

(F) Interim uses. The following are interim uses in a B-2 District and require an interim use permit based upon procedures set forth in and regulated by § 154.026 of this chapter: none.

SECTION 12. Section 154.086 is hereby amended to incorporate the amended zoning map as attached hereto.

BE IT FURTHER ORDAINED BY THE CITY COUNCIL FOR THE CITY OF DUNDAS:

1. This Ordinance shall become effective immediately upon its passage and publication in accordance with law.

APPROVED by the City Council, of Dundas, Minnesota, on this 28th day of August 2023.

CITY OF DUNDAS BY	<i>ť</i> :	ATTESTED:					
Glenn Switzer, Mayor		Jenelle Teppen, City Administrator/Clerk					
Ordinance 2023-07							
Switzer	Modory	La Croix	Swartwood	Gallagher			

Publication in Faribault Daily News on: August __, 2023

SUMMARY OF ORDINANCE 2023-07

CITY OF DUNDAS STATE OF MINNESOTA

An Ordinance Amending Chapter 154 Related to the Adoption of the B-3, General Business District and Modifications to Non-retail Uses in the B-2 District


The following is the official summary of Ordinance 2023-07, which was approved and adopted by the Dundas City Council on August 28, 2023:


Chapter 154, the City of Dundas Zoning Ordinance, is hereby amended to include the B-3 District which allows for additional non-retail commercial type uses and modifications to the B-2 District to remove the same uses. The amendment includes a map update.

A copy of the entire Ordinance 2023-07 is available for inspection by any person during regular office hours at the Dundas City Hall, 100 Railway Street North, Dundas, Minnesota 55019; and is posted at the Dundas City website: www.cityofdundas.org.

ADOPTED BY THE DUNDAS CITY COUNCIL on the 28th day of August 2023.

Published by order: Jenelle Teppen, City Administrator/Clerk in the *Faribault News* on _____, 2023

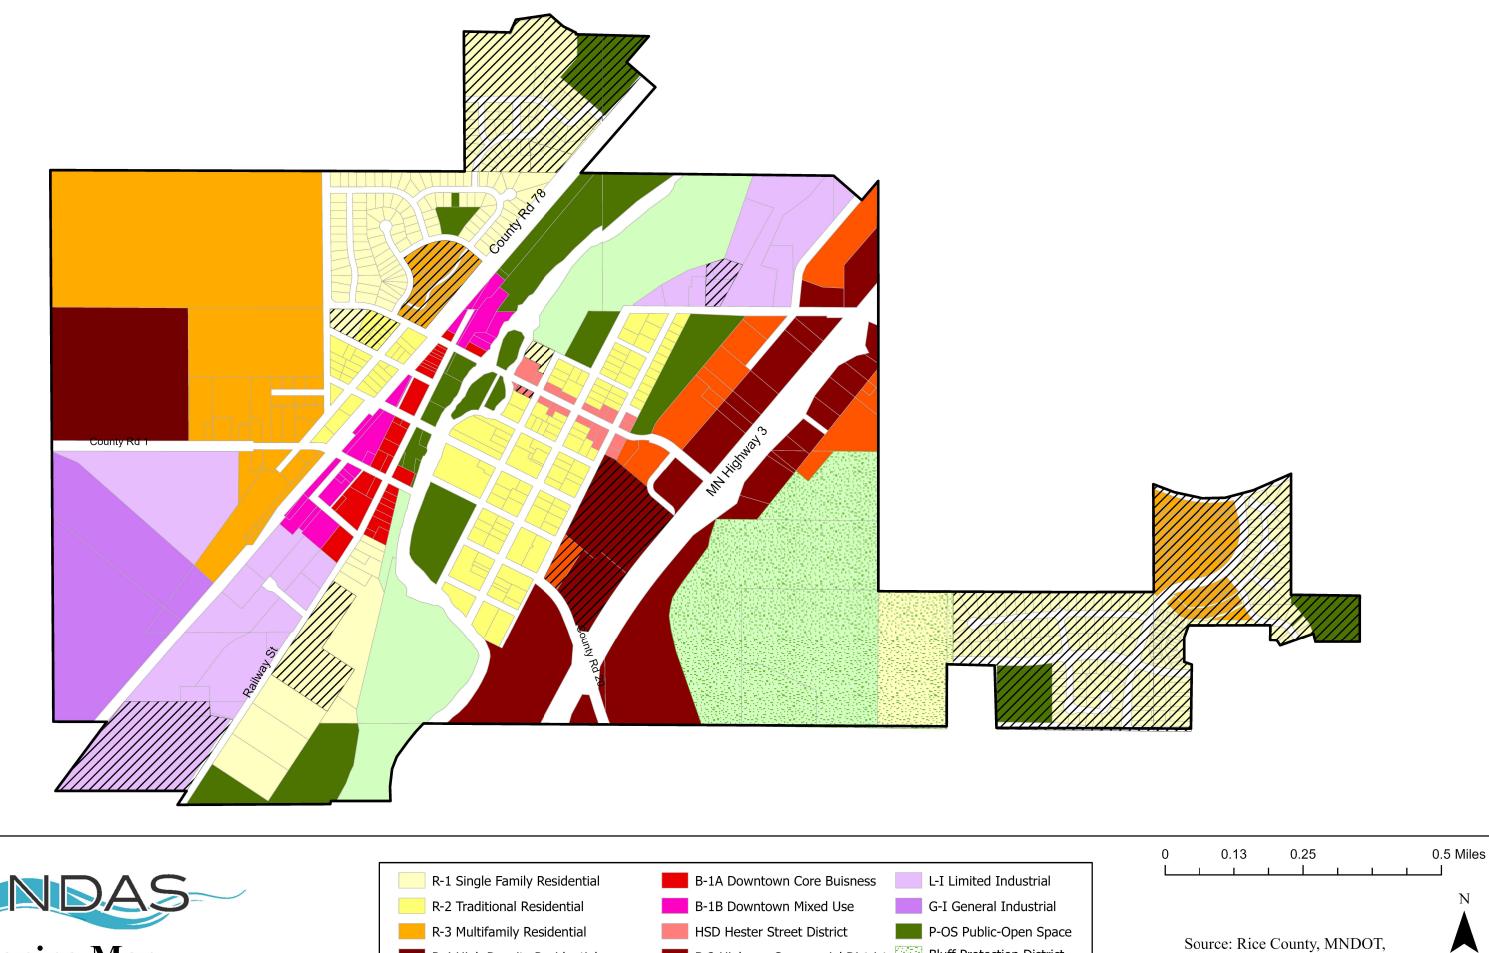

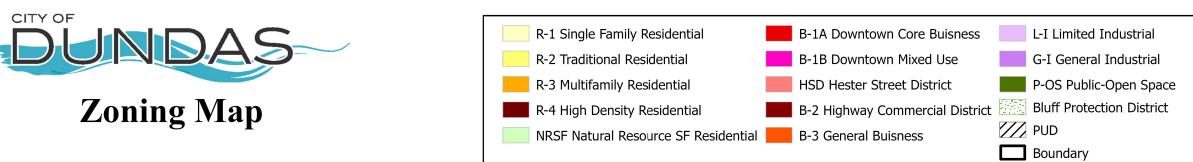

Northwest Associated Consultants

Map Updated: 08/17/23

